


NOTE: BASED ON FEMA MAP, THIS PROJECT SITE IS LOCATED IN AREA OF

MINIMAL FLOOD HAZARD ZONE

NOT TO SCALE

GALT JOINT UNION **ELEMENTARY SCHOOL DISTRICT** MAINTENANCE SHOP BUILDING

1019 BEAVER PARK WAY GALT, CALIFORNIA 95632

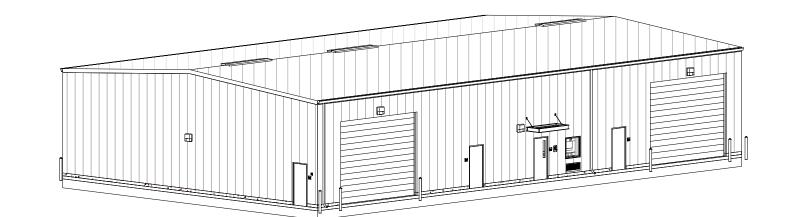

STATEMENT OF GENERAL CONFORMANCE PROJECT TEAM

THESE DRAWINGS AND/OR SPECIFICATIONS AND/OR CALCULATIONS FOR THE ITEMS LISTED IN THIS DOCUMENT SET OR LISTED FOR REFERENCE ONLY HAVE BEEN PREPARED BY OTHER DESIGN PROFESSIONALS OR CONSULTANTS WHO ARE LICENSED AND/OR AUTHORIZED TO PREPARE SUCH DRAWINGS IN THIS STATE. THESE DOCUMENTS HAVE BEEN EXAMINED BY ME FOR DESIGN INTENT AND APPEAR TO MEET THE APPROPRIATE REQUIREMENTS OF TITLE 24, CALIFORNIA CODE OF REGULATIONS AND THE PROJECT SPECIFICATIONS. THE ITEMS LISTED ABOVE HAVE BEEN COORDINATED WITH MY PLANS AND SPECIFICATIONS AND ARE ACCEPTABLE FOR INCORPORATION INTO THE CONSTRUCTION OF THIS PROJECT FOR WHICH I AM THE INDIVIDUAL DESIGNATED TO BE IN GENERAL RESPONSIBLE CHARGE, OR FOR WHICH I HAVE DELEGATED RESPONSIBILITY FOR THIS PORTION OF THE WORK.

THE PROJECT IS DESCRIBED AS THE CONSTRUCTION OF A

MAINTENANCE YARD. THE SCOPE OF WORK WILL INCLUDE AN

OPEN FLOOR PLAN, OFFICE/RESTROOM, ACCESSIBLE WALKWAY

RESTROOM. THIS BUILDING WILL NOT HOUSE STUDENTS. THE

NEW BUILDING WILL INCLUDE HEATING AND PHONE/DATA. IT IS

ASSUMED THE DISTRICT WILL PROCURE THE NEW BUILDING FROM

TO THE NEW BUILDING AS WELL AS A SINGLE-OCCUPANCY STAFF

PREFABRICATED 60'X100'METAL SHOP BUILDING AT ITS

2022CALIFORNIA ADMINISTRATIVE CODE - TITLE 24, Part 1

2022 CALIFORNIA BUILDING CODE - TITLE 24, Part 2

2022 CALIFORNIA ELECTRICAL CODE - TITLE 24, Part 3

2022 CALIFORNIA PLUMBING CODE - TITLE 24, Part 5

2022 CALIFORNIA ENERGY CODE - TITLE 24. Part 6

2022 CALIFORNIA MECHANICAL CODE - TITLE 24, Part 4

2022 CALIFORNIA GREEN BUILDING STANDARDS CODE - Part 11

2016 NFPA 13 STANDARD FOR THE INSTALLATION OF SPRINKLER

A COPY OF PARTS I & II OF THE TITLE 24 FOR ALL APPLICABLE PARTS

REFERENCED BY THE DRAWINGS AND SPECIFICATIONS SHALL BE

2016 NFPA 72 NATIONAL FIRE ALARM CODE & CA AMENDMENTS

KEPT AND AVAILABLE IN THE FIELD DURING CONSTRUCTION.

2022 CALIFORNIA REFERENCED STANDARDS CODE - Part 12

A TURNKEY DESIGN-BUILD VENDOR.

2022 CALIFORNIA FIRE CODE - Part 9

COSUMNES FIRE DEPARTMENT

FIRE SPRINKLER PLANS

ELECTRICAL DRAWINGS/SPECIFICATIONS BY: THE ENGINEERING ENTERPRISE CIVIL DRAWINGS / SPECIFICATIONS BY; WARREN CONSULTING ENGINEER INC.

RELIEVING ME OF MY RIGHTS, DUTIES, AND RESPONSIBILITIES UNDER SECTION 17302 AND 81138 OF THE EDUCATION CODE AND SECTIONS 4-336, 4-341" OF THE TITLE 24, PART 1 (TITLE 24, PART 1, SECTION 4-317(b).

ITEMS REVIEWED AND ACCEPTED ARE THE FOLLOWING DRAWINGS AS LISTED AS "DELEGATED DRAWINGS" IN THE SHEET INDEX

ADDITIONAL NOTES

Steve Sowa ARCHITECT LICENSE #: C-37459

01/04/2023 RENEWAL DATE: 08/32/2023 CONTACT: LOIS YOUNT GALT JOINT UNION ELEMENTARY SCHOOL DISTRICT 1018 C STREET, SUITE 210 GALT. CA 93660 PHONE: 209-744-4545 EXT. 315/311 E-MAIL: superintendent@galt.k12.ca.us

ARCHITECT CONTACT: Steve Sowa DERIVI CASTELLANOS ARCHITECTS, INC 3031 WEST MARCH LANE, SUITE 334 STOCKTON, CA 95219 PHONE: 408-320-4871 E-MAIL: ssowa@dcaaia.com


STRUCTURAL CONSULTANT CONTACT: TIMOTHY MATHEWSON MATHEWSON & ASSOCIATES INC 4120 DOUGLAS BLVD, #306-260 GRANITE BAY, CA 95746 PHONE: 916.508.9731 E-MAIL: tim@mathewson-assoc.com

CIVIL ENGINEERING CONTACT: Anthony Tassano Warren Consulting Engineers, inc. WARREN CONSULTING ENGINEERS INC 1117 Windfield Way Suite 110, El Dorado Hills. CA 95762 PHONE: (916) 985-1870 E-MAIL: anthony@wceinc.com

PLUMB/MECH ENGINEER CONTACT: Matt Warriner WESTON & ASSOCIATES 601 UNIVERSITY AVE, SUITE 260 SACRAMENTO, CA 95825 PHONE: (916) 482-0820 EXT. 102 E-MAIL: mwarriner@weston-me.com

ELECTRICAL ENGINEER CONTACT: Danny McKevitt THE ENGINEERING ENTERPRISE 1125 HIGH STREET AUBURN, CA 95603 PHONE: (916) 398-0813 E-MAIL: dmckevitt@engent.com

SHEET INDEX

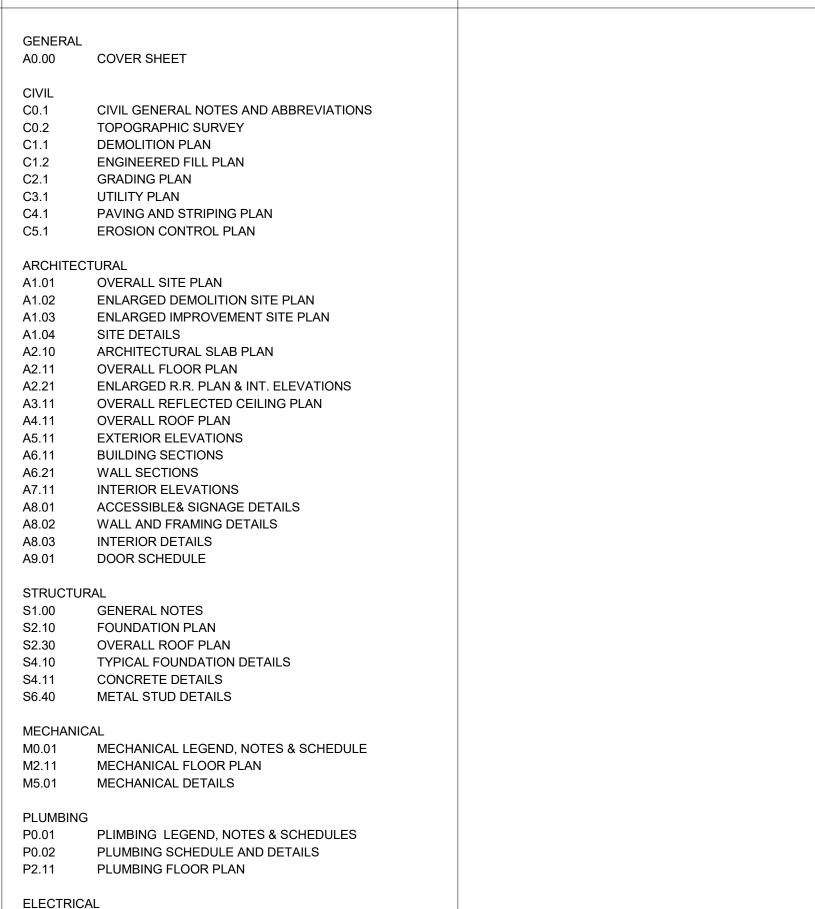

SYMBOLS LIST, ABBREAVIATIONS AND SHEET INDEX

SCHEDULES AND NOTES

ELECTRICAL SITE PLAN

POWER & SIGNAL PLAN

ELECTRICAL DETAILS

LIGHTING PLAN

FIRE ALARM

FA0.1 OVERALL PLAN

PRE-FAB METAL BUILDING

TOTAL SHEETS: : 46

COVER SHEET

Professional Seals

Castellano: Architects

NO NO NO

SHEET TITLE: **COVER SHEET**


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SCHEMATIC DESIGN

Revision Schedule Description


PROJECT # SHEET # **ISSUE DATE:** 03-14-2023


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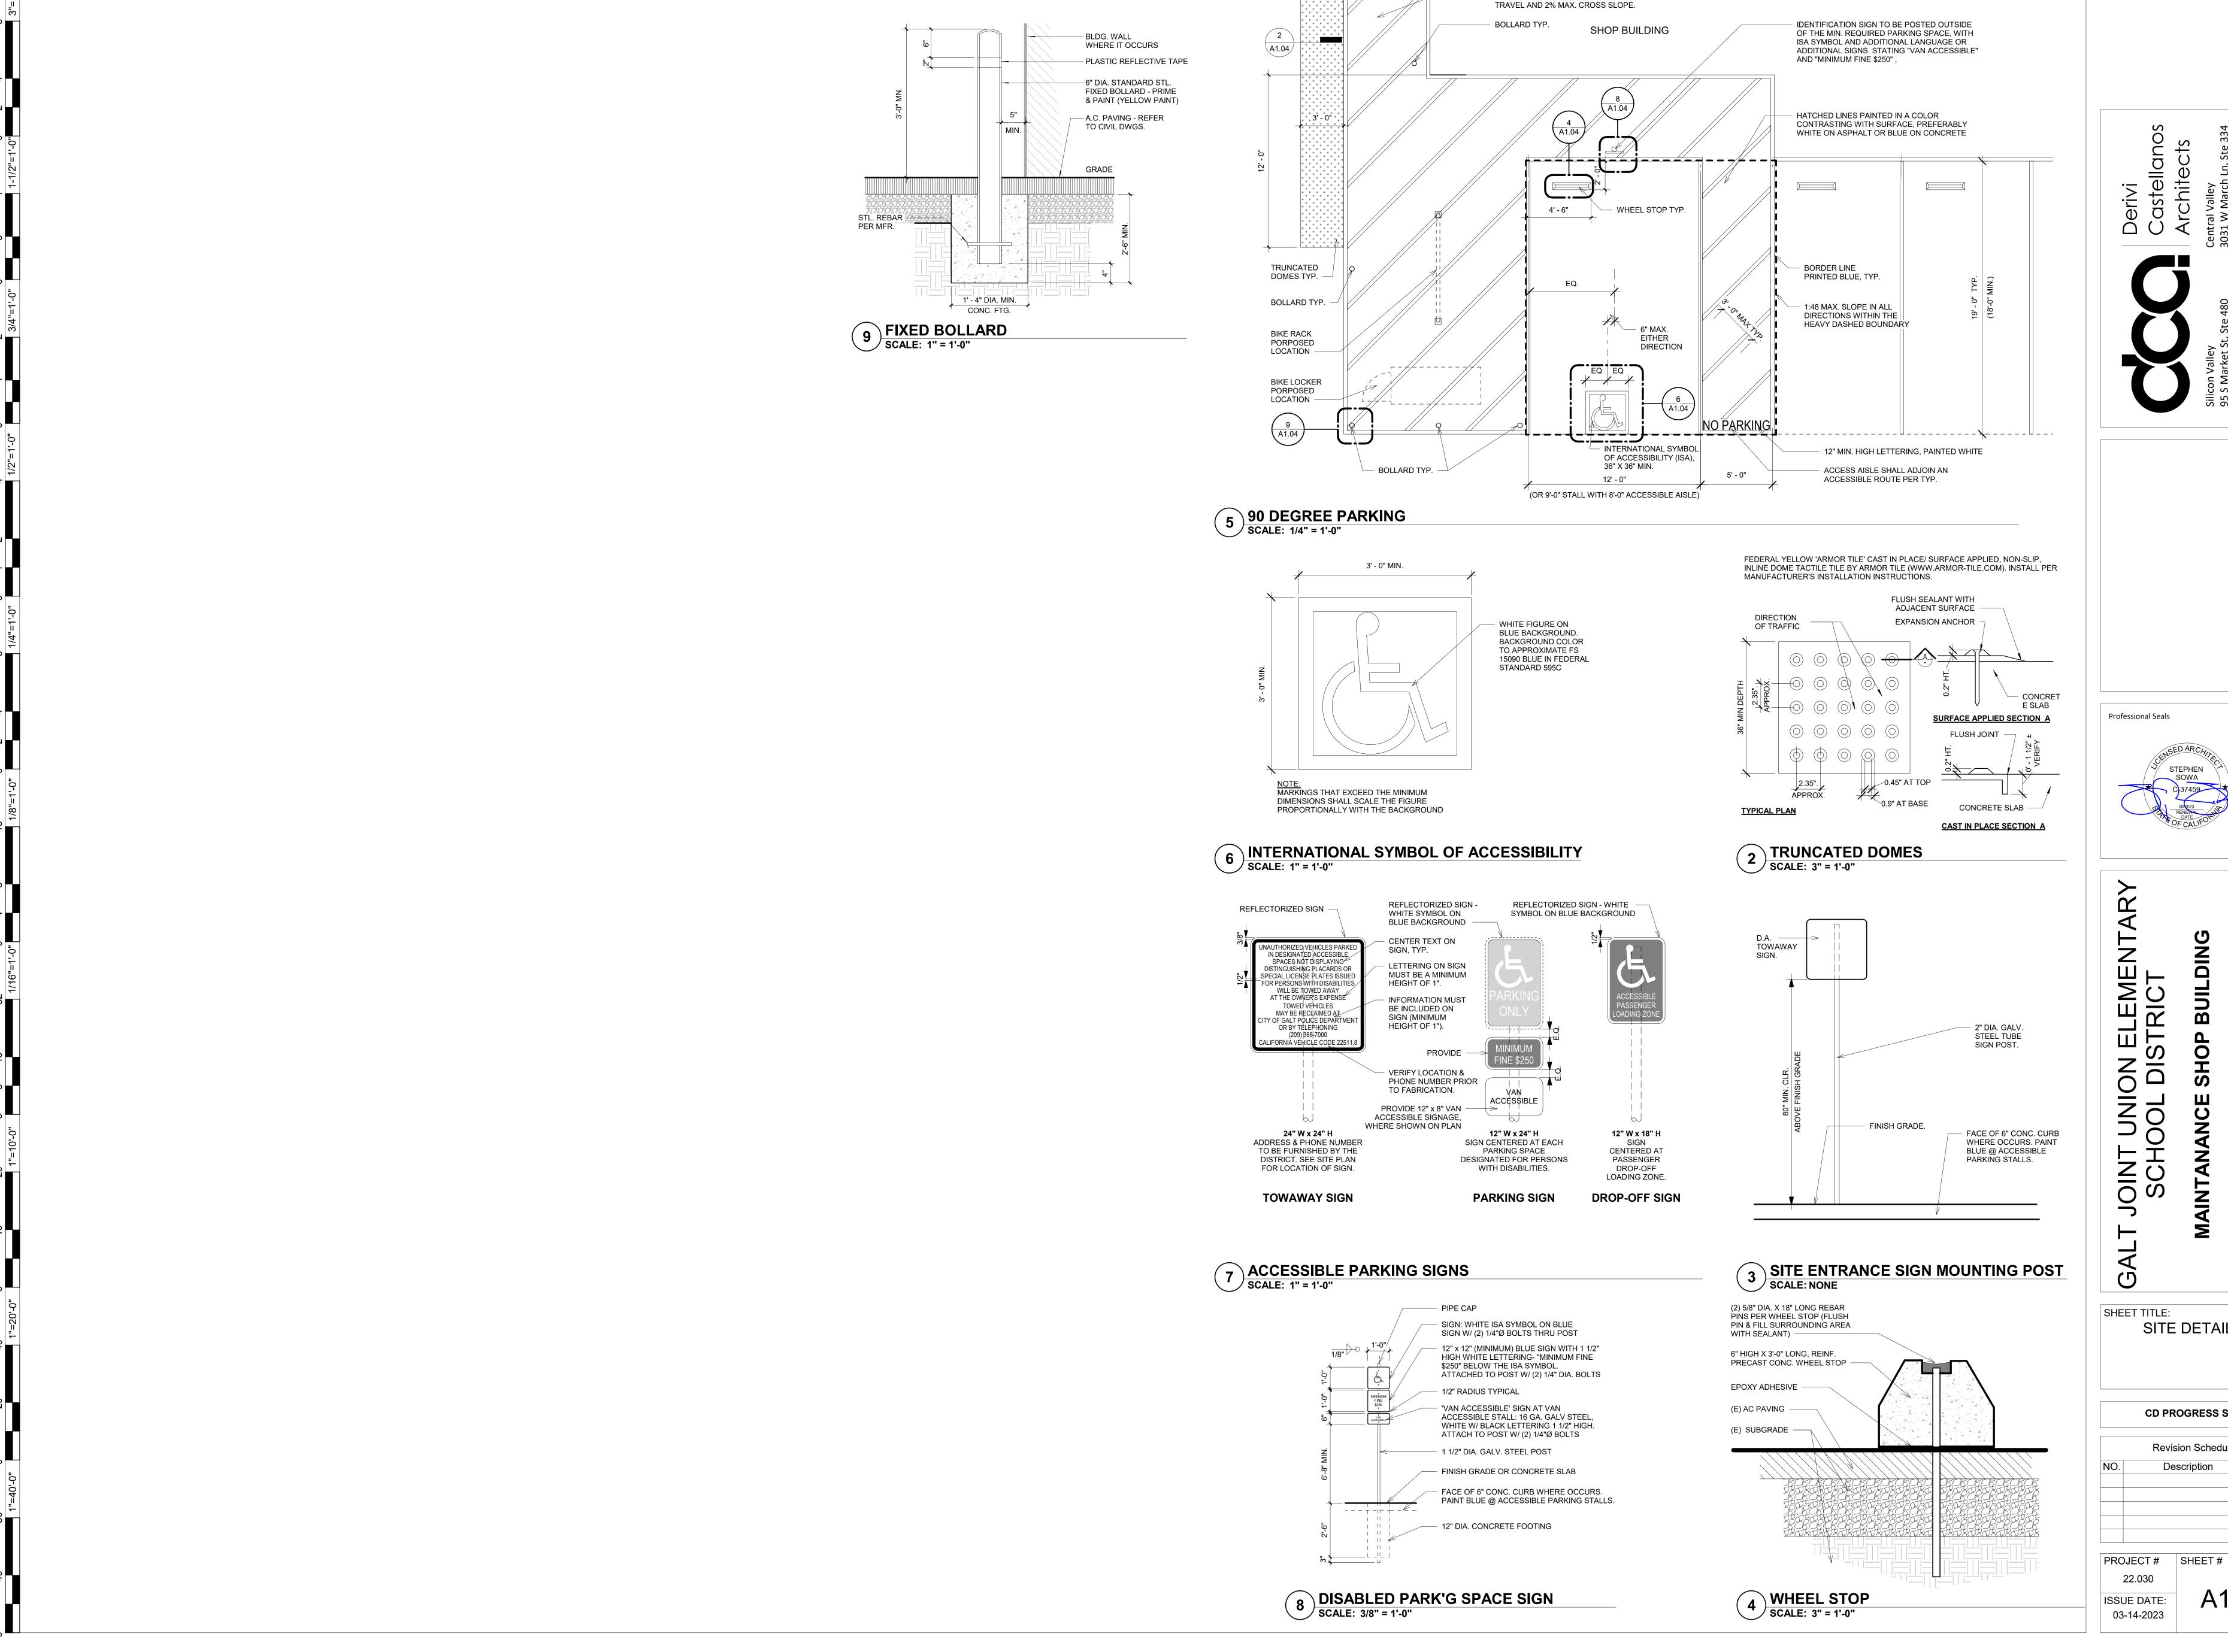


SHEET NOTES SHEET TITLE:

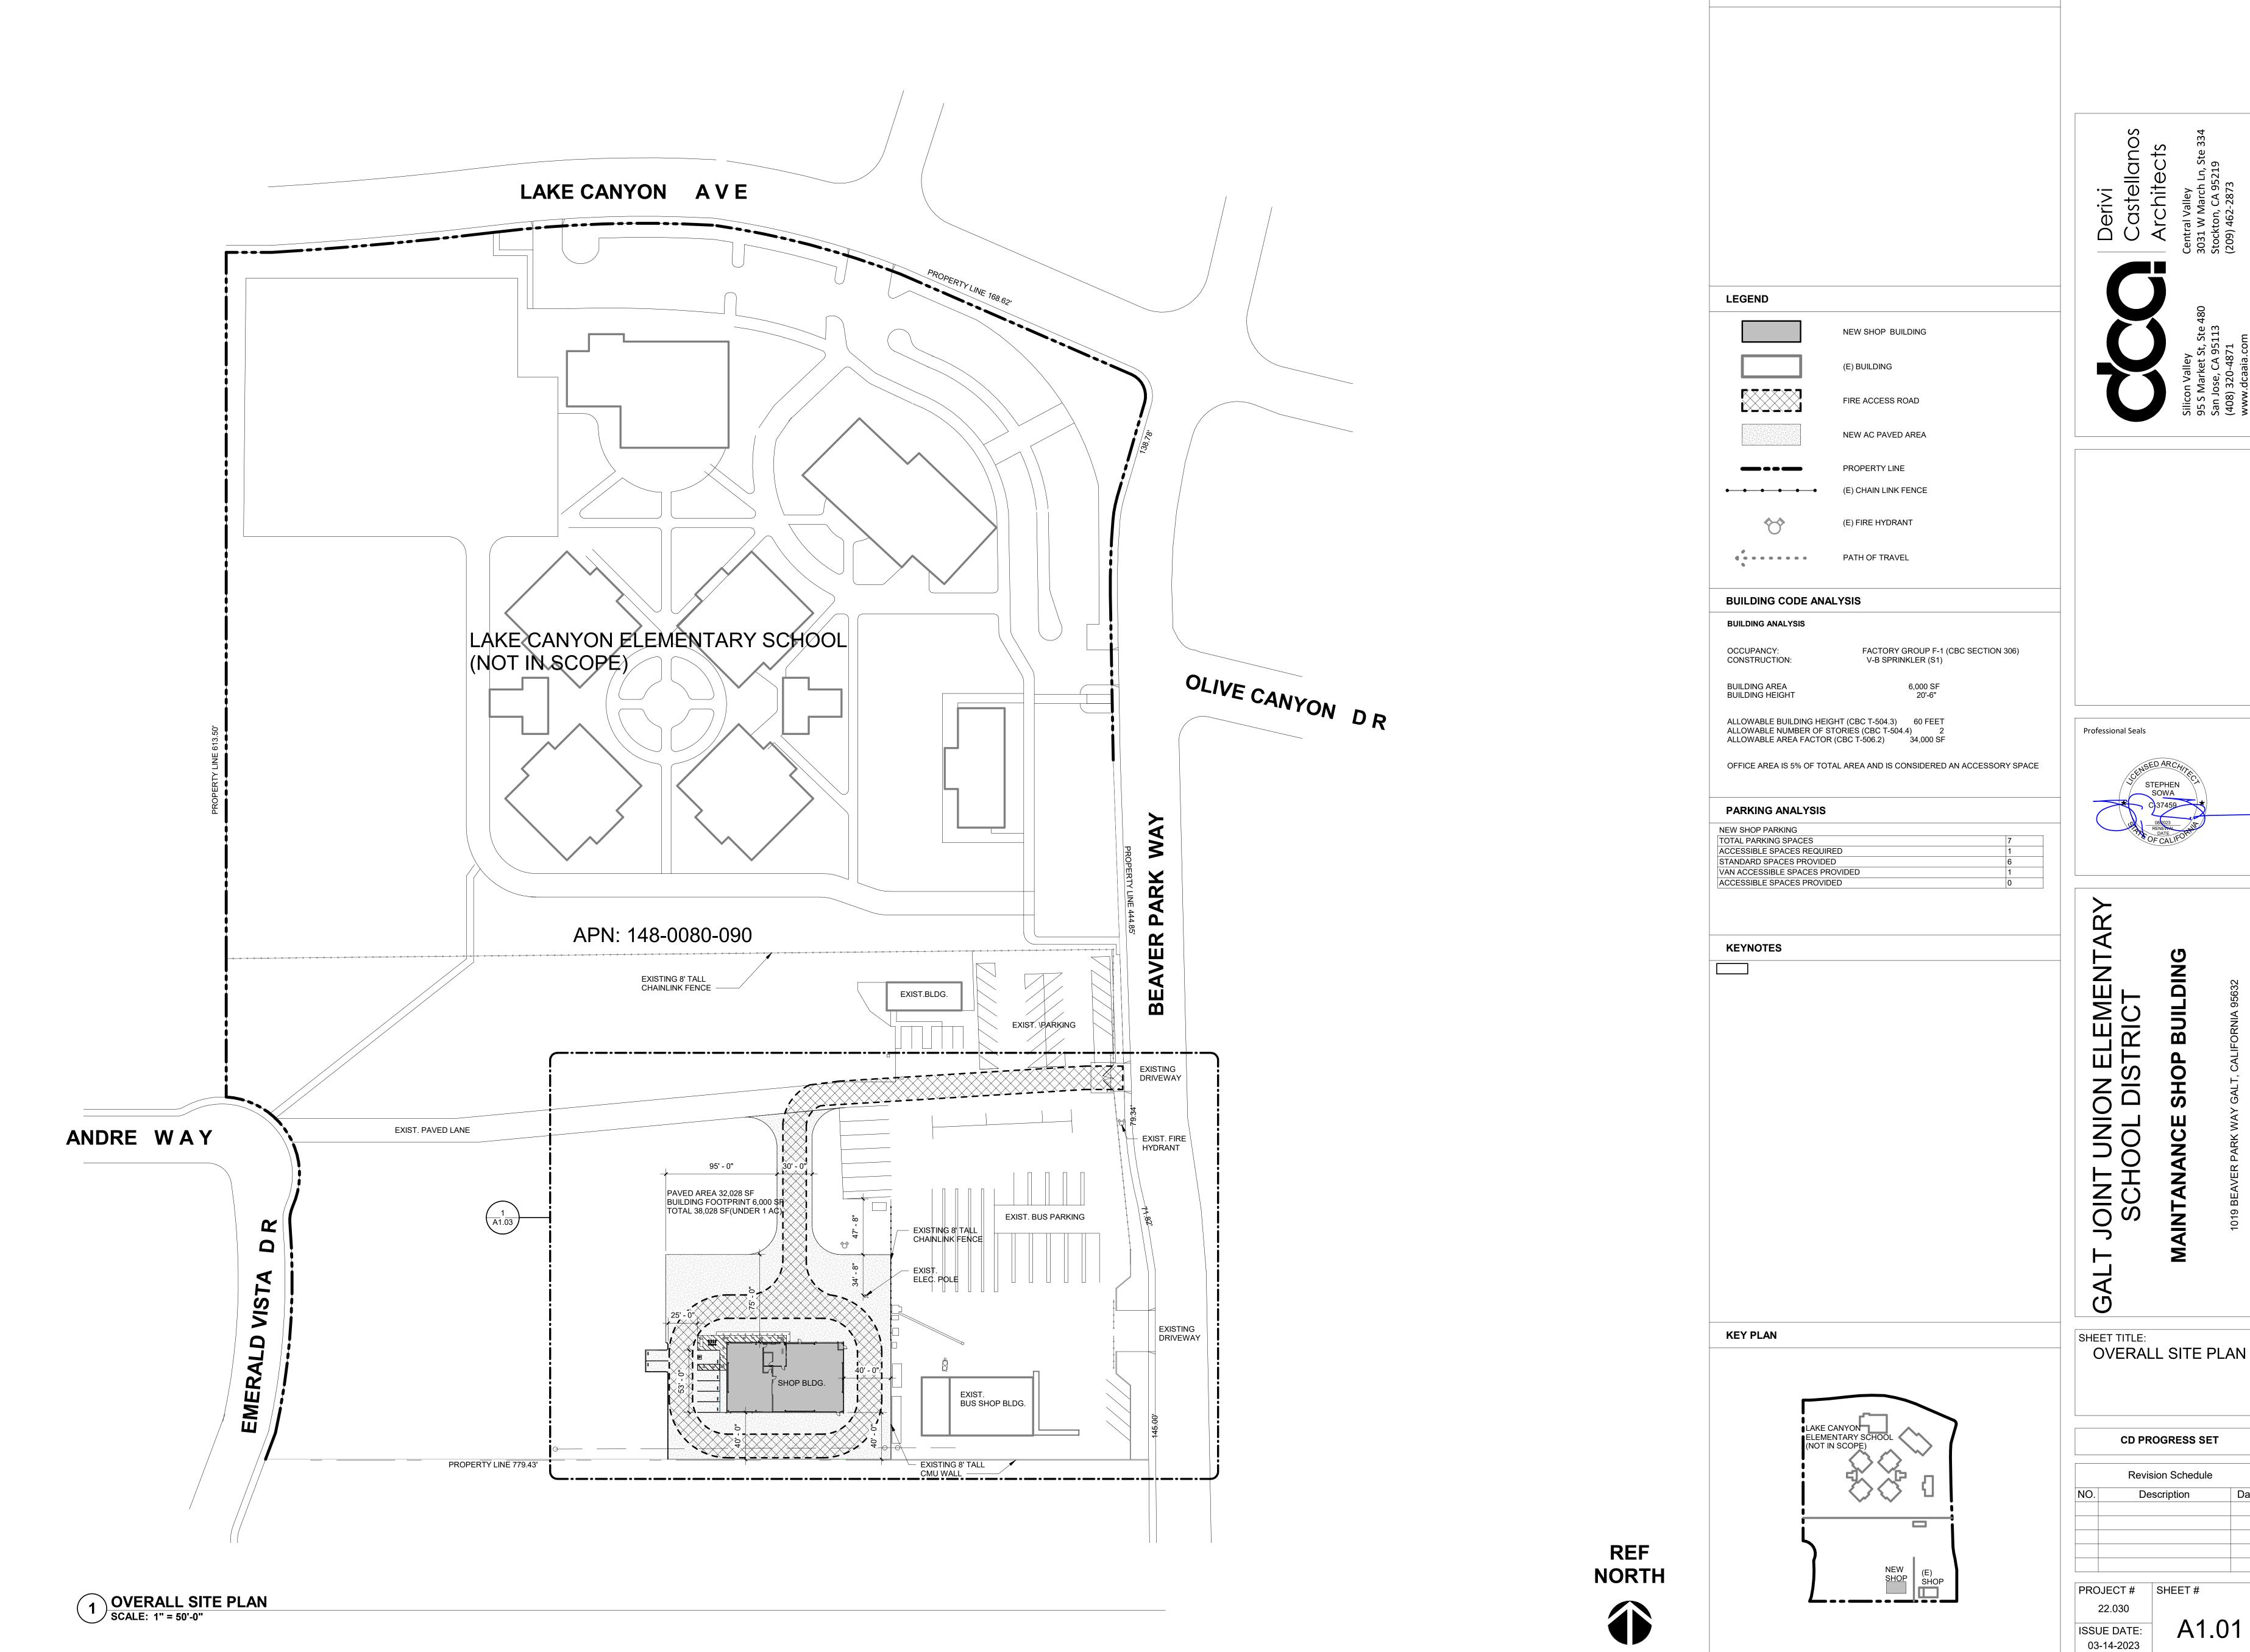OVERALL SITE PLAN



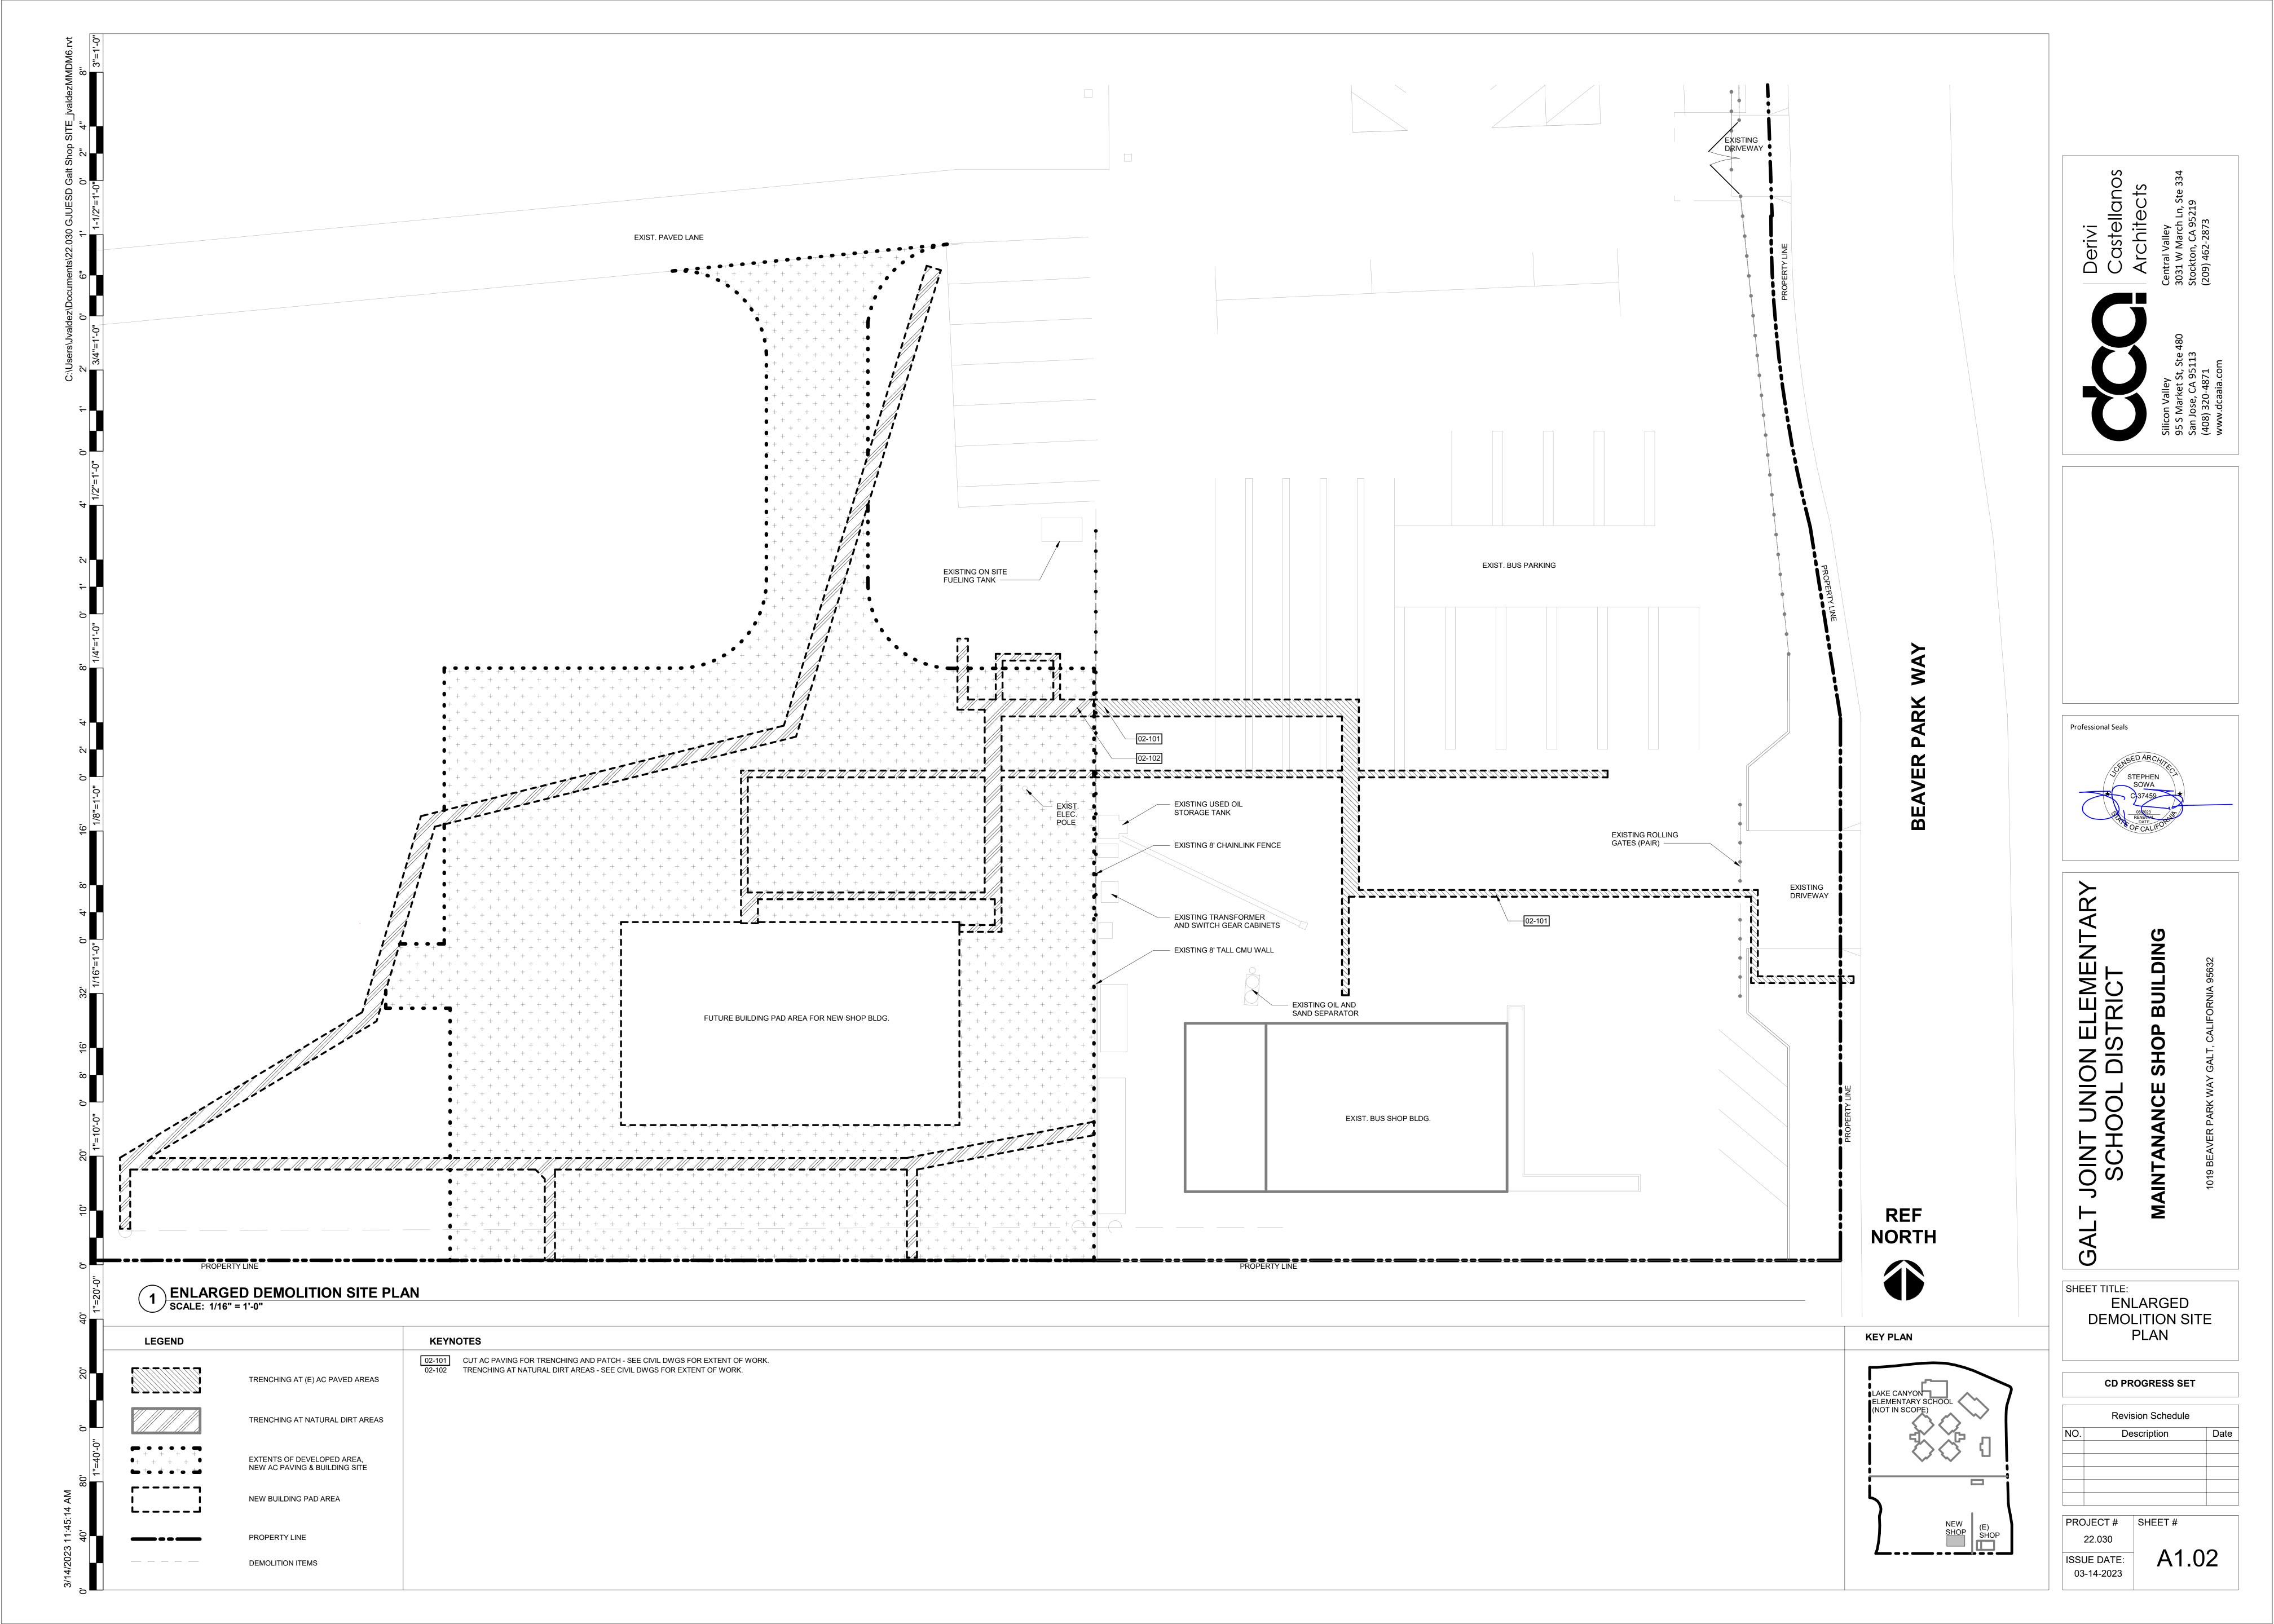

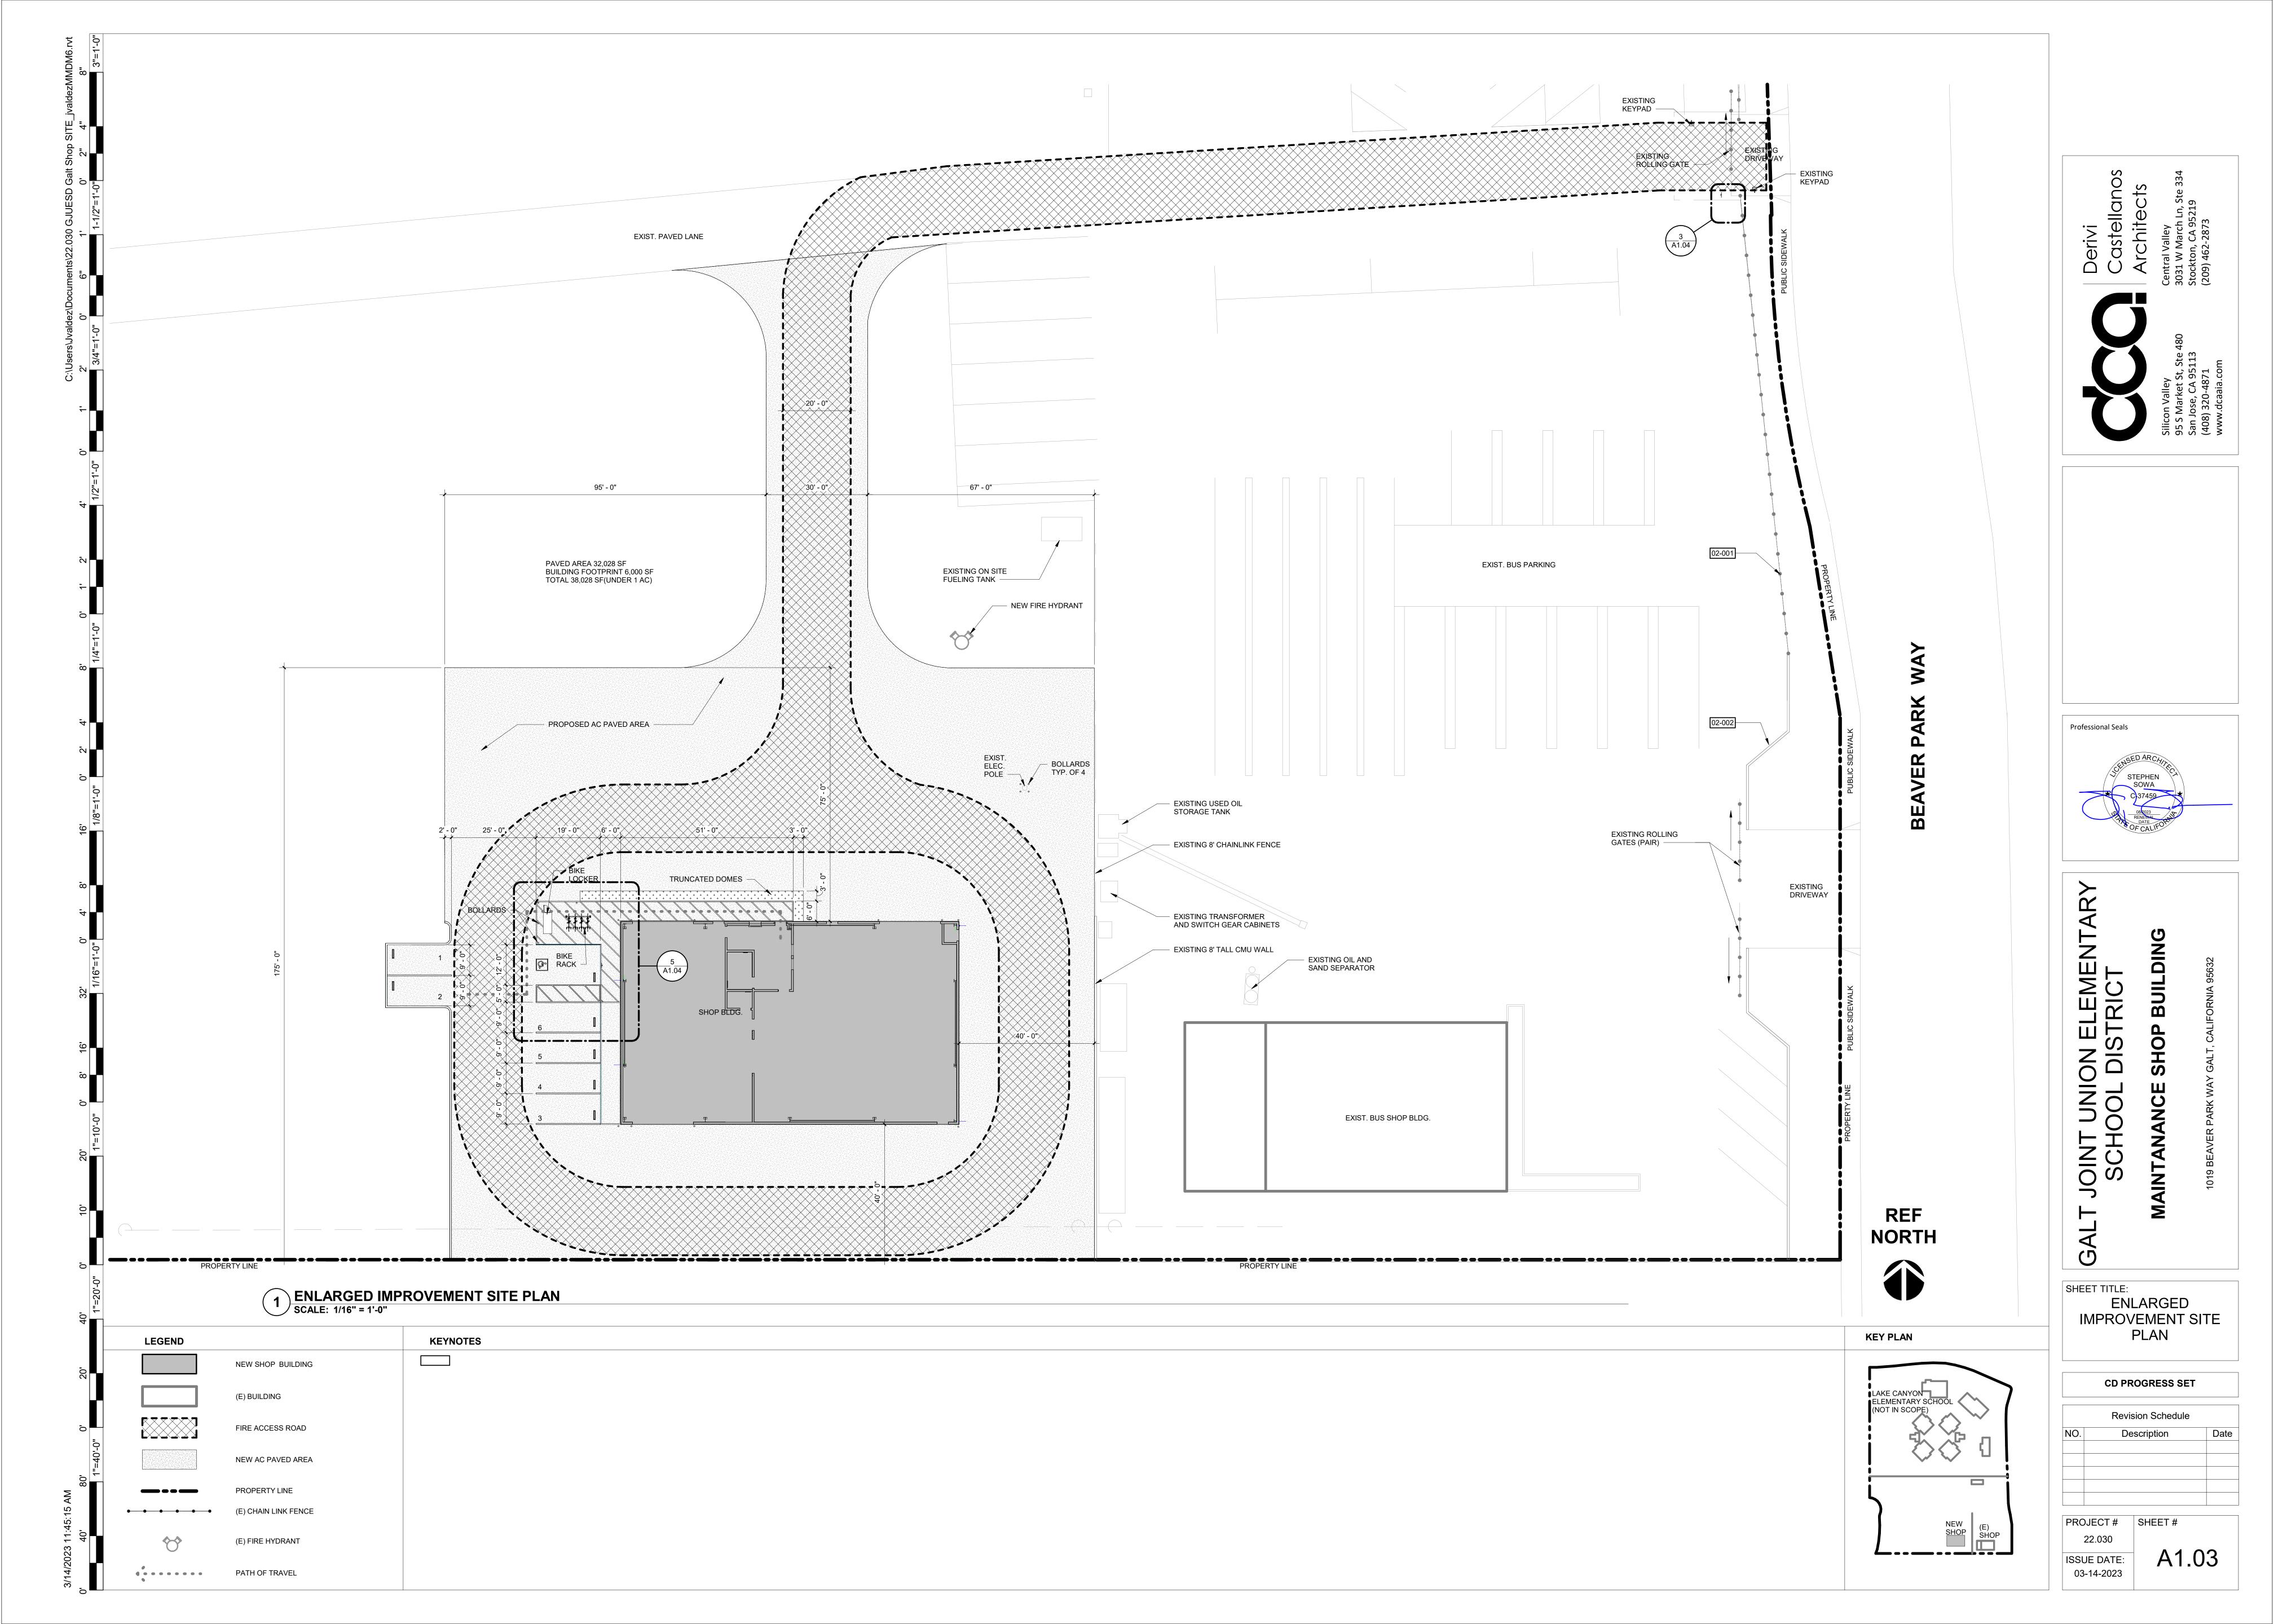

STRIPPED ACCESSIBLE PATH OF TRAVEL 5% MAX. SLOPE IN DIRECTION OF



SITE DETAILS

CD PROGRESS SET

Revision Schedule Description

A1.04

1 ARCHITECTURAL SLAB PLAN SCALE: 1/8" = 1'-0"



SLAB PLAN LEGEND

KEYNOTES

KEY PLAN

LAKE CANYON ELEMENTARY SCHOOL (NOT IN SCOPE)

NEW SHOP

6" HIGH CONCRETE CURB. PATCH VOIDS AS REQ. FOR SMOOTH SURFACE

03-001

03-008

6" HIGH CONCRETE CURB

1" DEEP TOOLED CONTROL JOINT TYPICAL. - SPACE JOINTS
(IN FEET) 2-3 TIMES SLAB THICKNESS (IN NCHES)

05-004 RIGID FRAME COLUMN - FACTORY FINISHED POWDER COATED - SEE SHOP DWGS.

22-005 FLOOR DRAIN - SEE PLUMBING SPECS

Professional Seals




UNION ELEMENTARY JOL DISTRICT

SHEET TITLE:
ARCHITECTURAL SLAB PLAN

SCHEMATIC DESIGN

Revision Schedule Description

PROJECT # SHEET # 03-14-2023

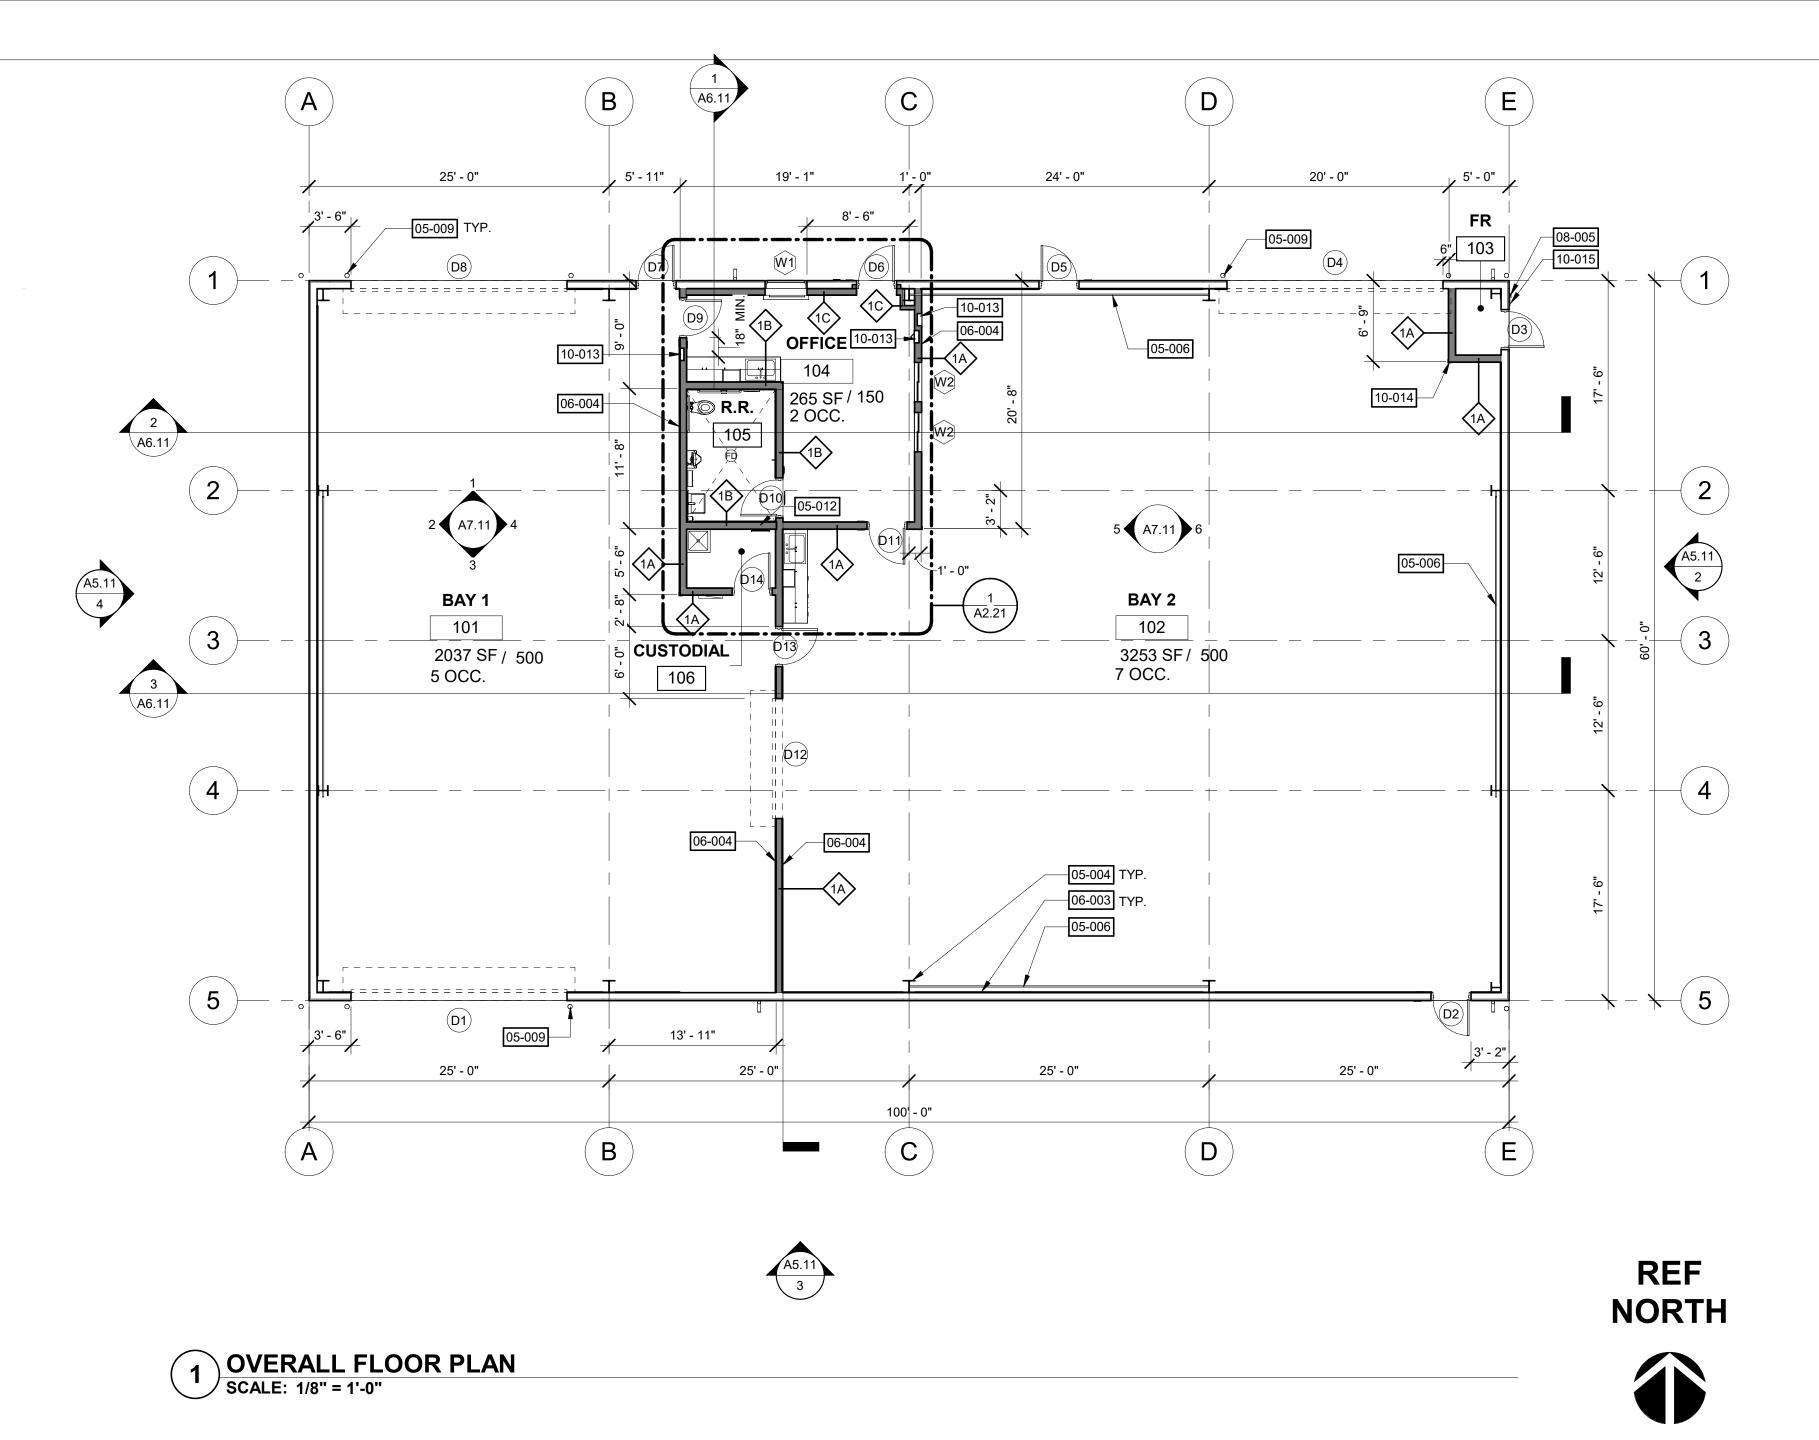

	FINISH SCHEDULE											
		FLOOR		WALL		CEILING						
NO.	ROOM	FINISH	WALL BASE	WALL TYPE	WALL FINISH	TYPE	FINISH	Comments				
101	BAY 1	FLR-1	B-1	W-3	P-2	CL-2		REFER TO INTERIOR ELEVATIONS FOR PLYWD LOCATIONS				
102	BAY 2	FLR-1	B-1	W-3	P-2	CL-2		REFER TO INTERIOR ELEVATIONS FOR PLYWD LOCATIONS				
103	FR	FLR-1	B-1	W-2	P-1	CL-2						
104	OFFICE	FLR-1	B-2	W-2	P-1	CL-1	P-1					
105	R.R.	FLR-1	B-3	W-1 / W-2	P-1	CL-1	P-1					
106	CUSTODIAL	FLR-1	B-3	W-1 / W-2	P-1	CL-2	P-1	-				

- 1 REFER TO INTERIOR ELEVATIONS FOR LOCATIONS OF MULTIPLE WALL FINISHES WITHIN A ROOM.
- 2 SEE INTERIOR ELEVATIONS FOR HEIGHTAND LOCATION OF PLYWOOD PANELING

FINISH LEGEND

MARK	DESCRIPTION	MFR. / BRAND	COLOR / FINISH	COMMENTS
B-1	CONCRETE CURB			6" CONCRETE CURB
B-2	COVEDCONCRETE CURB			1/2" RAD. COVED
B-3	RUBBER BASE	TBD	TBD	
CL-1	GYP. BD. TAPED, TEXTURED AND PAINTED			
CL-2	EXPOSED CEILING			EXPOSED PRE-FAB MTL BLDG CEILING
FLR-1	CONCRETE		TBD	SEALED
P-1	PAINT	BENJAMIN MOORE		AT GYP. BD LOCATIONS
P-2	PAINT	BENJAMIN MOORE		AT PLYWOOD PANELING
W-1	FIBERGLASS REINFORCED PANEL	TBD		
W-2	GYPSUM BOARD - TAPED, TEXTURED & PAINTED.		P-1	
W-3	PLYWOOD PANELING		P-2	7' TALL PLYWOOD PANELING

GENERAL FINISH NOTES

- A. WHERE MULTIPLE WALL FINISHES ARE CALLED OUT, REFER TO INTERIOR ELEVATIONS FOR LOCATIONS OF INDIVIDUAL FINISHES.
- B. WHERE MULTIPLE FLOOR FINISHES ARE CALLED OUT, REFER TO FLOOR PLANS FOR LOCATIONS OF INDIVIDUAL FINISHES.
- WHERE MULTIPLE CEILING FINISHES ARE CALLED OUT, REFER TO REFLECTED CEILING PLANS FOR LOCATIONS OF INDIVIDUAL FINISHES
- D. REFER TO FINISH SCHEDULE REMARKS FOR ADDITIONAL FINISH REQUIREMENTS

FINISH SCHEDULE REMARKS


- 1. FINISH GYPSUM BOARD TO A LEVEL 5 FINISH
- 2. SEE KEYNOTES ON REFLECTED CEILING PLAN FOR SPECIFIC CEILING WORK IN THIS ROOM.
- 3. PAINT SHEEN TO BE SEMI-GLOSS.
- 4. MINIMUM 4" HIGH 3/8" RADIUS CONTINUOUS COVE BASE.

PLUMBING FIXTURE COUNT PER PLUMBING CODE **TABLE A** OCCUPANCY S (WAREHOUSE) 5,000 OCCUPANT LOAD FACTOR TOTAL BUILDING 7,500 SF / 5,000 SF = 1.5 OCCUPANTS PER PLUMBING CODE **TABLE 422.1** S-1, S-2 OCCUPANCIES WATER CLOSETS 1: 1-100 (FIXTURE PER PERSON) MALE/FEMALE 1 REQUIRED LAVATORIES 1: 1-200 (FIXTURE PER PERSON) MALE/FEMALE= 1 REQUIRED=1 REQUIRED SERVICE SINK OR LAUNDRY TRAY ... URINALS PER SUB-NOTE (3) URINALS PERMITTED TO BE OMITTED • DRINKING FOUNTAINS NOT REQUIRED ON OCCUPANT LOAD OF 30 OR LESS PER CPC 415.2 PER CPC SECTION 422.2 SEPARATE FACILITIES EXCEPTION (2) - OCCUPANCIES WITH A TOTAL OCCUPANT LOAD OF 10 OR LESS ONE TOILET FACILITY IS PERMITTED. PROVIDED SINGLE OCCUPANCY ALL GENDER RESTROOM THAT INCLUDES: 1 WATER CLOSET 1 LAVATORY 1 URINAL 1 MOP SINK IN CUSTODIAL ROOM

GENERAL NOTES

- MECHANICAL, ELECTRICAL, AND PLUMBING ITEMS INDICATED ON THIS SHEET ARE FOR REFERENCE ONLY. REFER TO RESPECTIVE DISCIPLINE DWGS. FOR CONSTRUCTION DWG INFORMATION.
- B PROVIDE 6" CONCRETE CURB AS INDICATED ON DRAWINGS.
- REFER TO ENLARGED RESTROOM FLOOR PLAN AND DETAILS FOR COMPLETE RESTROOM CONSTRUCTION DOCUMENTATION INFORMATION.
- D CASEWORK INDICATED ON THIS SHEET IS FOR GENERAL INFORMATION ONLY. SEE INTERIOR ELEVATIONS AND CASEWORK SCHEDULE FOR COMPLETE CONSTRUCTION DOCUMENTATION
- REFER TO WINDOW SCHEDULE SHEET A10.1 FOR WINDOW TYPES AND
- ALL WINDOWS MAY NOT BE REFERENCED ON FLOOR PLANS. REFER TO EXTERIOR ELVATIONS FOR WINDOW REFERENCES ABOVE THE HEIGHT LIMIT OF THESE FLOOR PLANS.
- G REFER TO DOOR SCHEDULE SHEET A10.1 FOR DOOR TYPE AND DIMENSIONS.
- H ALL WALLS / BASE TO BE PAINTED.

LEGEND

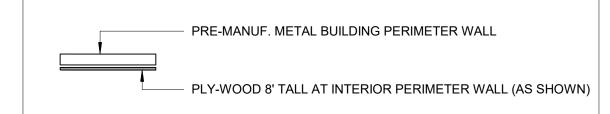

NEW NON-RATED LIGHT GAGE METAL STUD FRAMED WALL

WALL TYPE TAG SEE SHEET A8.02 FOR WALL ASSEMBLY DETAIL

DOOR REFERENCE NUMBER

WINDOW REFERENCE NUMBER

Room name ROOM REFERENCE 101

RIGID FRAME COLUMN - SEE MTL BLDG SHOP DWGS

WALL TYPES

WALL ASSEMBLY DESCRIPTION 1A 6" MTL STUD @ 16" O.C. w/ R-15 INSULATION, 5/8" TYPE 'X' GYP. BD. EACH SIDE, S.S.D. PROVIDE FIREBLOCKING PER 2019 CBC 718.2.2. FRAME FULL HEIGHT. 1B 6" MTL STUD @ 16" O.C. w/ R-15 INSULATION, 5/8" TYPE 'X' GYP. BD. EACH SIDE FRAME 6" ABOVE CEILING 1C 6" MTL STUD @ 16" O.C. w/ R-15 INSULATION, 5/8" TYPE 'X' GYP. BD. ONE SIDE ONLY FRAME 6" ABOVE CEILING

KEYNOTES

KEY PLAN

- 05-004 RIGID FRAME COLUMN FACTORY FINISHED POWDER COATED SEE SHOP DWGS.
- 05-006 PRE-FAB METAL BUILDING CROSS BRACING SEE SHOP DWGS. 05-009 4" DIA. X 36" TALL STEEL BOLLARD FILLED WITH CONCRETE - INSTALL AT BLDG CORNER & AT ROLL-UP DOOR JAMBS TYP.
- 05-012 ATTIC ACCESS LADDER
- 06-003 PLYWOOD 7' HIGH OR TO GIRT AT DOOR HEADER HT.- PRIME PAINT 06-004 PLYWOOD 7' HIGH TO SUBISTUTE 5/8" GYP BD. AT BASE.- PRIME PAINT

LAKE CANYON ELEMENTARY SCHOOL

SHOP

(NOT IN SCOPE)

- 08-005 MOTORIZED CONTROLLED ROLL-UP DOOR SEE SPECS & DOOR SCHEDULE 10-013 FIRE EXTINGUISHER MIN. RATING 2A:20-B:C
- 10-014 STAINLESS STEEL CORNER GUARDS 10-015 FIRE RISER ROOM SIGN

Professional Seals



Castellanos Architects

ELEMEI


NOINN SID TOC OIN

SHEET TITLE: OVERALL FLOOR PLAN

SCHEMATIC DESIGN

Revision Schedule Description

PROJECT # SHEET # 22.030 ISSUE DATE: 03-14-2023

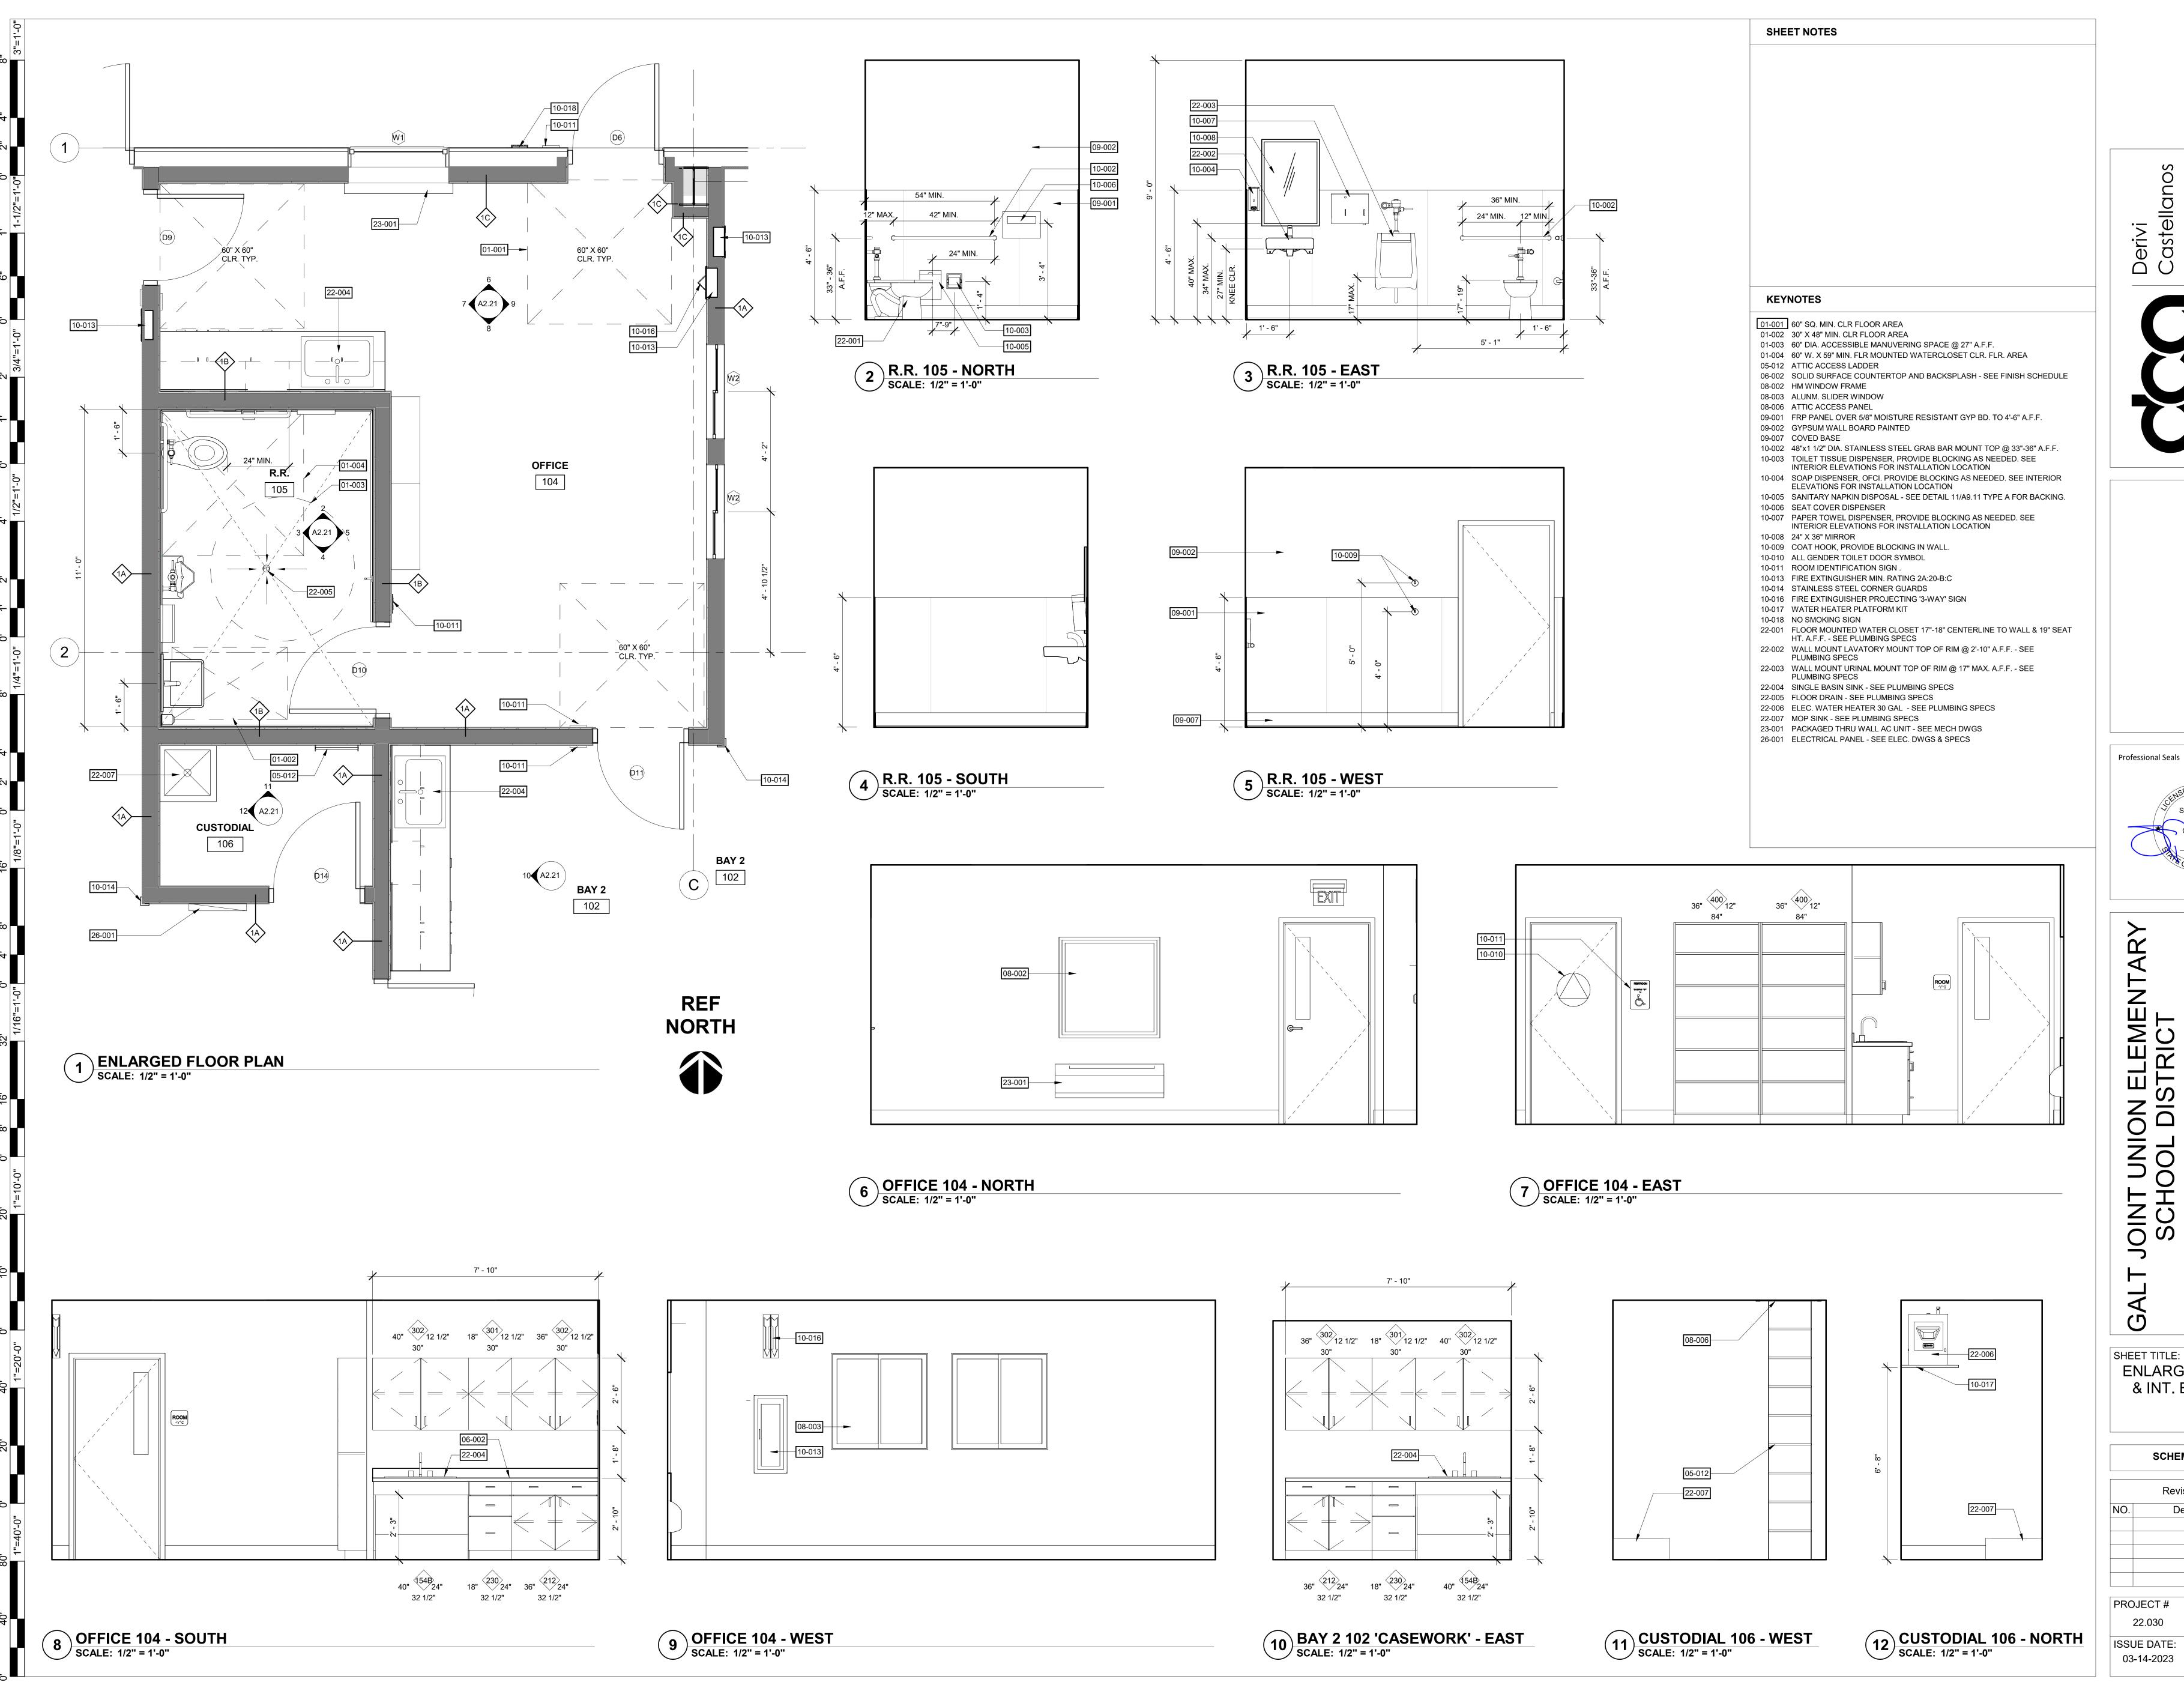

SHEET TITLE: ENLARGED R.R. PLAN & INT. ELEVATIONS

SCHEMATIC DESIGN

Revision Schedule Description

PROJECT # SHEET # 22.030 ISSUE DATE:

A2.21

OVERALL REFLECTED CEILING PLAN
SCALE: 1/8" = 1'-0"

SHEET NOTES

- A CEILINGS HEIGHT INDICATED SHALL BE MEASURED FROM THE FINISH FLOOR TO THE FINISH SURFACE OF THE CEILING.
- CONTRACTOR SHALL COORDINATE THE INSTALLATION OF VARIOUS TRADE ITEMS WITHIN THE SPACE ABOVE THE CEILING, INCLUDING BUT NOT LIMITED TO: STRUCTURAL MEMBERS, MECHANICAL DUCTS, INSULATION, CONDUIT RACEWAYS, FIRE SPRINKLER PIPING, LIGHT FIXTURES, AND SUSPENDED CEILING SYSTEMS.
- C ACCESS PANELS SHALL BE PROVIDED AS REQUIRED FOR PROPER OPERATION AND MAINTENANCE OF MECHANICAL OR ELECTRICAL EQUIPMENT. WHETHER OR NOT INDICATED ON THE DRAWINGS.




KEYNOTES

LEGEND

EXHAUST / RETURN / SUPPLY

05-005 RIGID FRAME RAFTER - FACTORY FINISHED POWDER COATED - SEE SHOP DWGS.
05-006 PRE-FAB METAL BUILDING CROSS BRACING - SEE SHOP DWGS. 05-010 PRE-FAB METAL CANNOPY AT MAIN ENTRY BY METAL BUILDING MANUFACTURER - SEE SHOP DWGS.

- 05-012 ATTIC ACCESS LADDER 07-006 EXPOSED VINYL FACED R-19 INSULATION AT ROOF
- 08-006 ATTIC ACCESS PANEL
- 21-001 FIRE SPRINKLER PIPING SEE FIRE SPRINKLER PLANS
- 23-002 GAS FIRED UNIT HEATER SEE MECH DWGS 26-002 SUSPENDED LIGH FIXTURE - SEE ELEC. DWGS & SPECS
- 26-004 CEILING FANS SEE ELEC. DWGS & SPECS

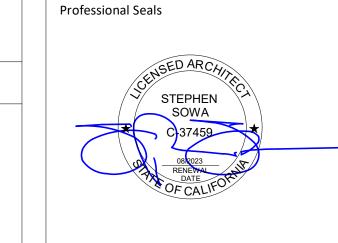

MECHANICAL REGISTERS - S.M.D. SURFACE MOUNTED LIGHT FIXTURE - S.E.D. PENDANT LIGHT FIXTURE - S.E.D.

EXPOSED VINYL FACED INSULATIN AT SHOP


GYPSUM WALLBOARD OVER METAL

CEILING JOISTS

CEILING FAN - S.E.D.

ILLUMINATED EXIT SIGN - S.E.D.

KEY PLAN

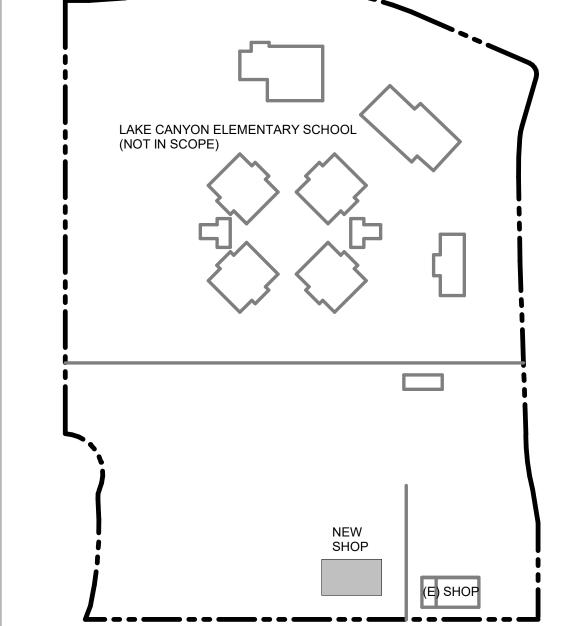

JOINT UNION ELEMENTARY SCHOOL DISTRICT GAL SHEET TITLE: OVERALL REFLECTED **CEILING PLAN**

SCHEMATIC DESIGN

Revision Schedule Description

03-14-2023

PROJECT # SHEET #

NORTH

SHEET NOTES

- REFER TO MECHANICAL, PLUMBING, AND ELECTRICAL DRAWINGS FOR EXTENT OF MECHANICAL, PLUMBING, AND ELECTRICAL WORK.
- ALL EXPOSED SHEET METAL SHALL BE PRIMED AND FIELD PAINTED PROVIDE TAPERED INSUILATION CRICKETS AT ALL ROOF ACCESSORIES AS REQUIRED TO ENSURE POSITIVE DRAINAGE.
- PROVIDE TAPERED INSULATION (TO COMPLY W/ FLAME SPREAD AND SMOKE DENSITY REQUIREMENTS OF CBC 707.3) TO SLOPE TO DRAIN. SIZE OF MECHANICAL EQUIPMENT PADS ARE FOR REFERENCE ONLY. THE CONTRACTOR SHALL VERIFY REQUIRED PAD DIMENSION WITH EQUIPMENT MANUFACTURER.
- ROOF CRICKETS, WHERE INDICATED, SHALL BE PROVIDED AS REQUIRED TO ENSURE A MINIMUM 1/4" PER FOOT VALLEY SLOPE. COORDINATE LOCATIONS OF CRICKETS WITH ROOFTOP EQUIPMENT.
 - REFER TO TYPICAL SADDLE FLASHING DETAILS WHERE 2 EXTERIOR WALLS OF DIFFERENT HEIGHTS INTERSECT.

05-010 PRE-FAB METAL CANNOPY AT MAIN ENTRY BY METAL BUILDING MANUFACTURER - SEE SHOP DWGS. 07-008 PREFINISHED GSM GUTTER w/ DEBRIS SCREEN - COLOR TO MATCH METAL ROOF



LEGEND

KEYNOTES


23-003 10' LONG RIDGE VENT

PRE-FAB BLDG METAL ROOF PANELS - DESERT SAND PUDF

RIDGE VENT

METAL CANOPY

KEY PLAN

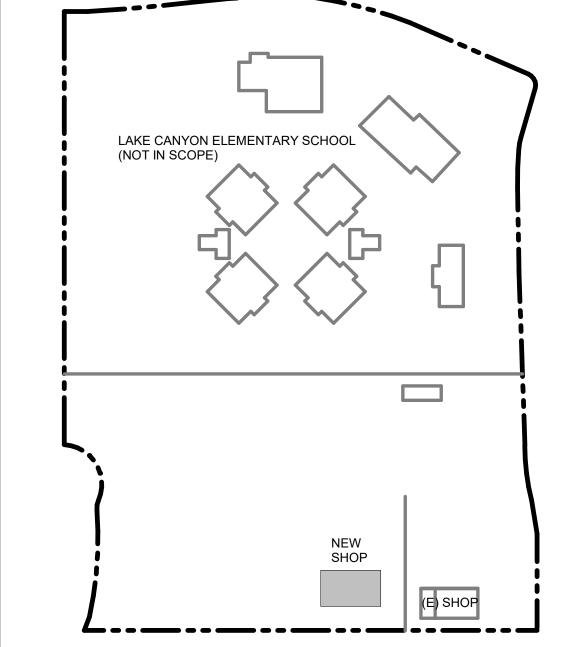

JOINT UNION ELEMENTARY SCHOOL DISTRICT GALT


SHEET TITLE:

OVERALL ROOF PLAN

SCHEMATIC DESIGN Revision Schedule Description

PROJECT # SHEET #


03-14-2023

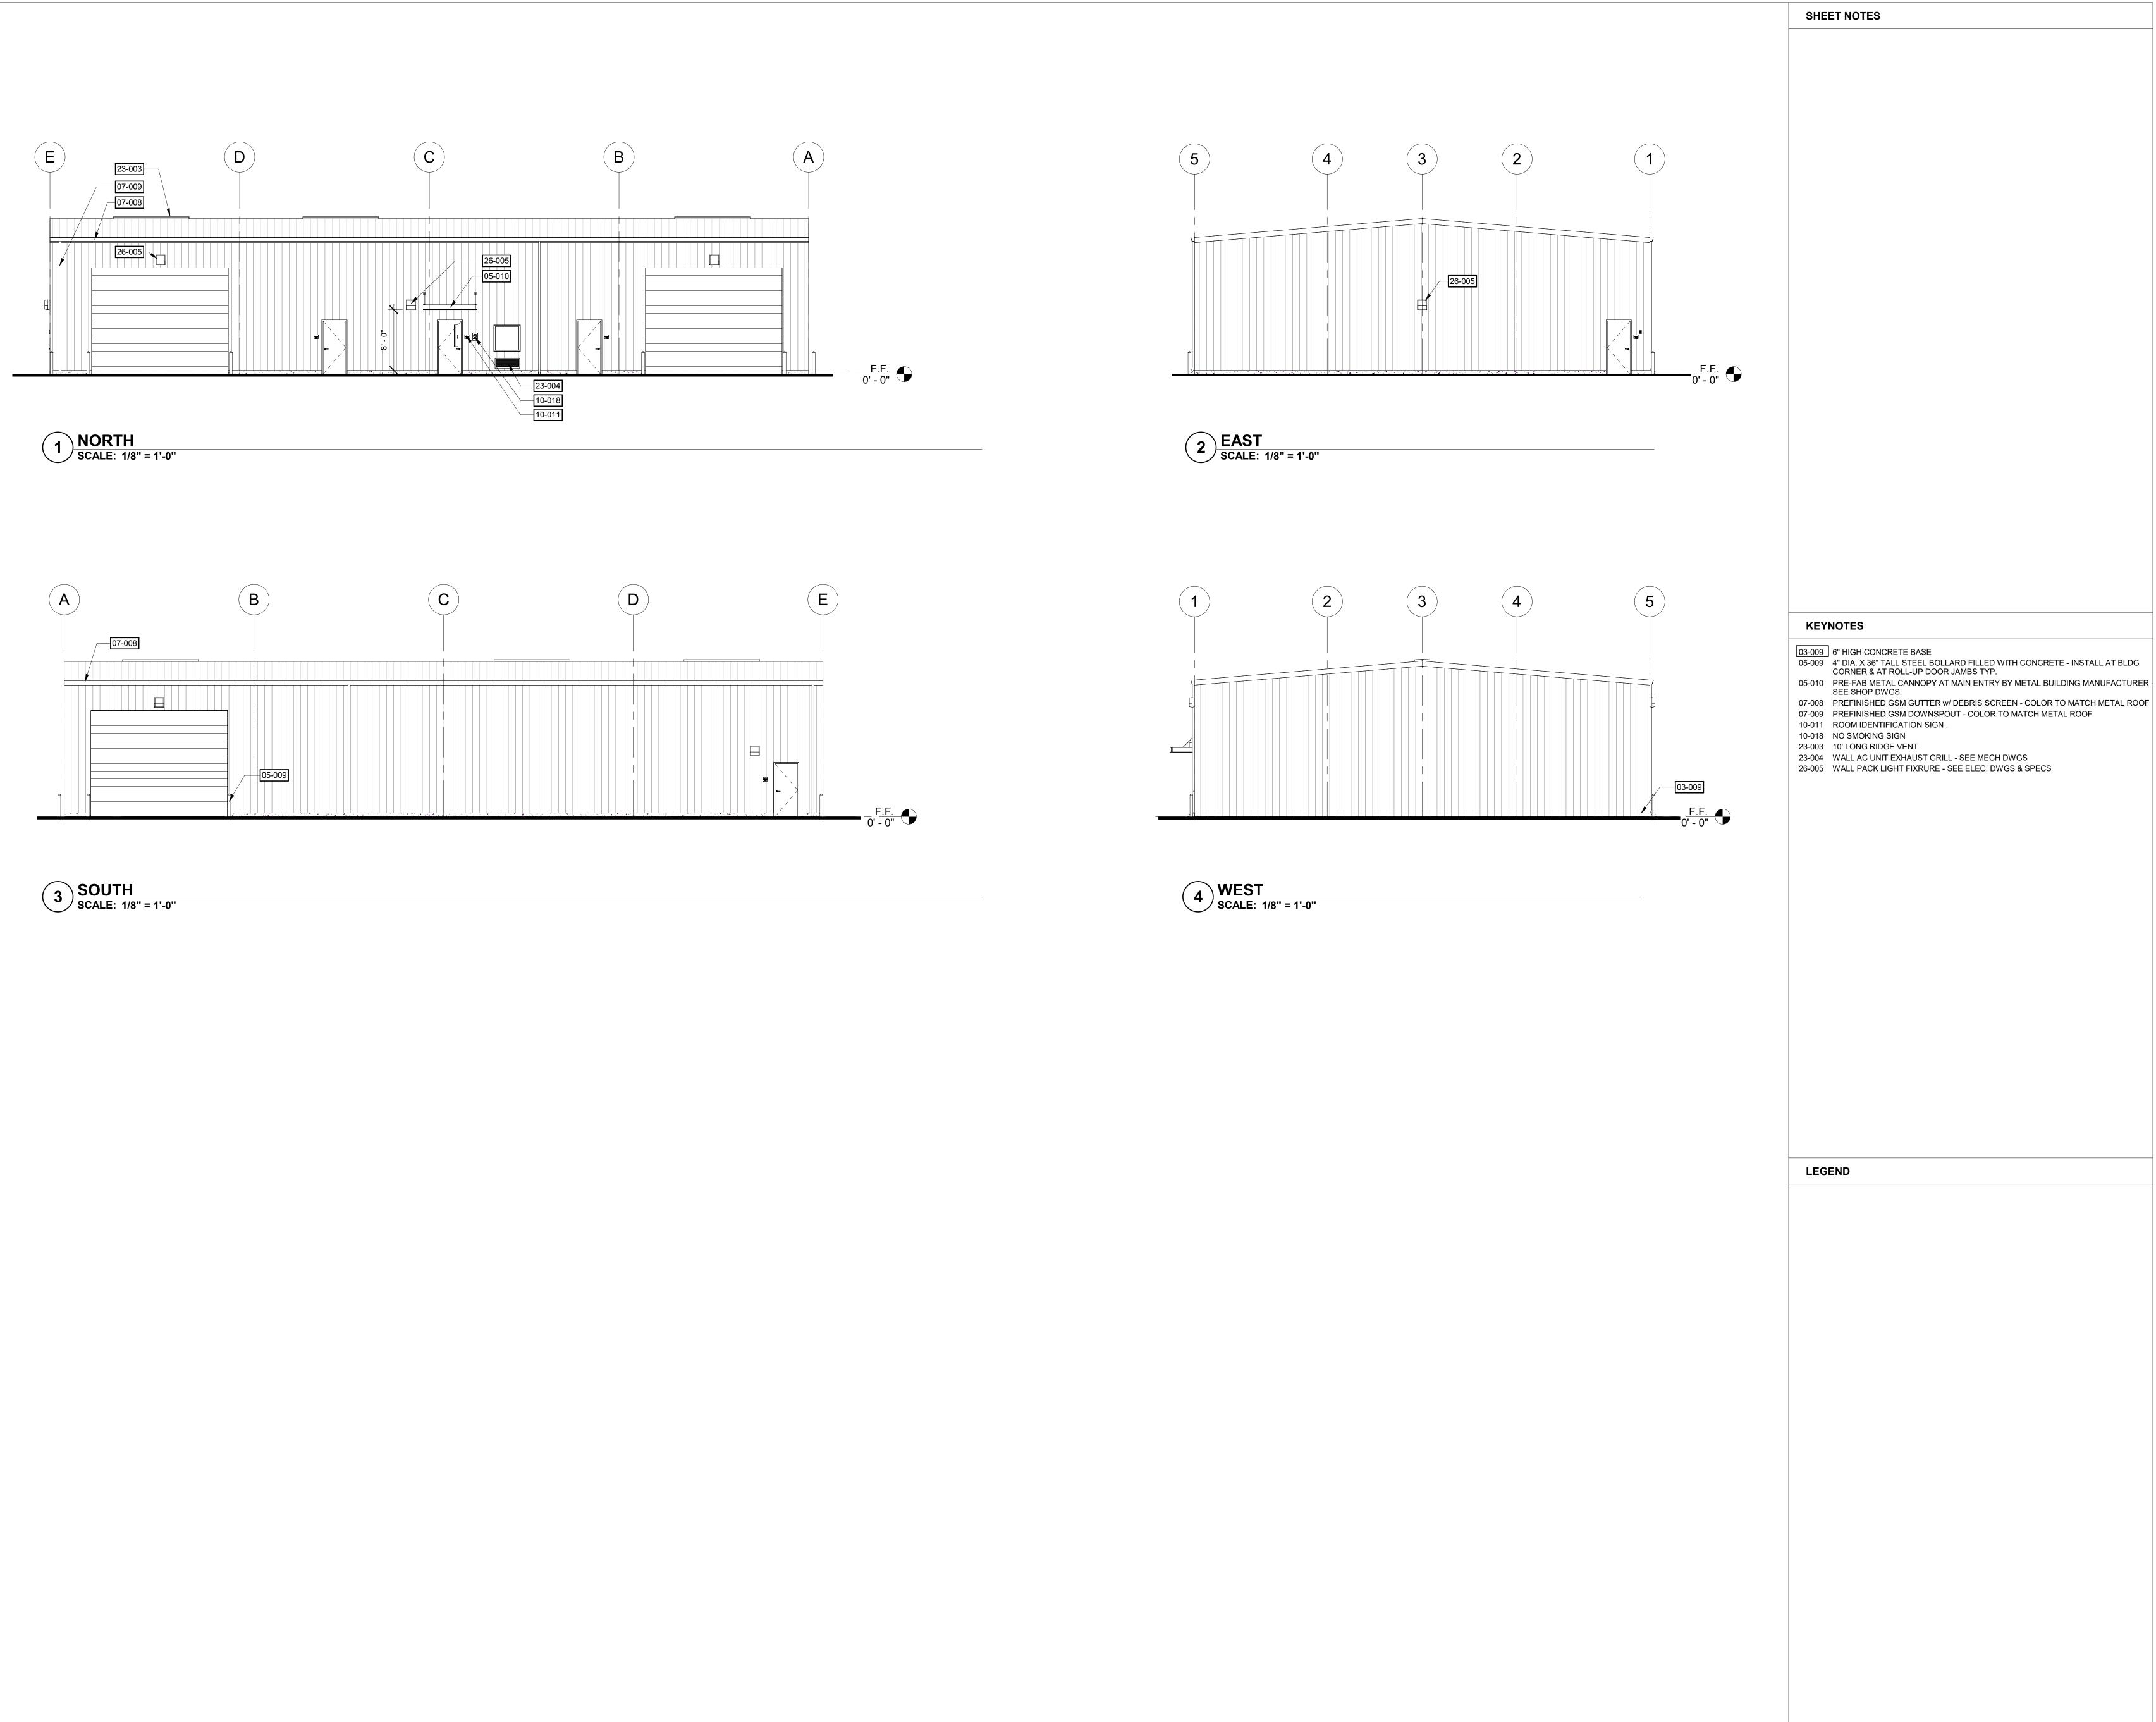

03-009 6" HIGH CONCRETE BASE
05-009 4" DIA. X 36" TALL STEEL BOLLARD FILLED WITH CONCRETE - INSTALL AT BLDG CORNER & AT ROLL-UP DOOR JAMBS TYP.

05-010 PRE-FAB METAL CANNOPY AT MAIN ENTRY BY METAL BUILDING MANUFACTURER - SEE SHOP DWGS.

Professional Seals

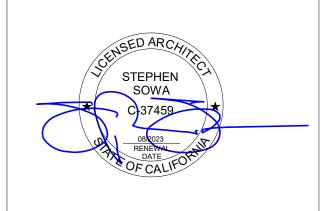

JOINT UNION ELEMENTARY SCHOOL DISTRICT

GAL SHEET TITLE:

EXTERIOR

TVATION **ELEVATIONS**

SCHEMATIC DESIGN

Revision Schedule Description

PROJECT # SHEET # 22.030 ISSUE DATE:

03-14-2023

KEYNOTES 21-001 FIRE SPRINKLER PIPING - SEE FIRE SPRINKLER PLANS
26-004 CEILING FANS - SEE ELEC. DWGS & SPECS JOINT UNION ELEMENTARY SCHOOL DISTRICT LEGEND GALT

SHEET NOTES

Professional Seals


SHEET TITLE:
BUILDING SECTIONS

SCHEMATIC DESIGN

Revision Schedule Description

PROJECT # SHEET # 22.030 ISSUE DATE:

03-14-2023

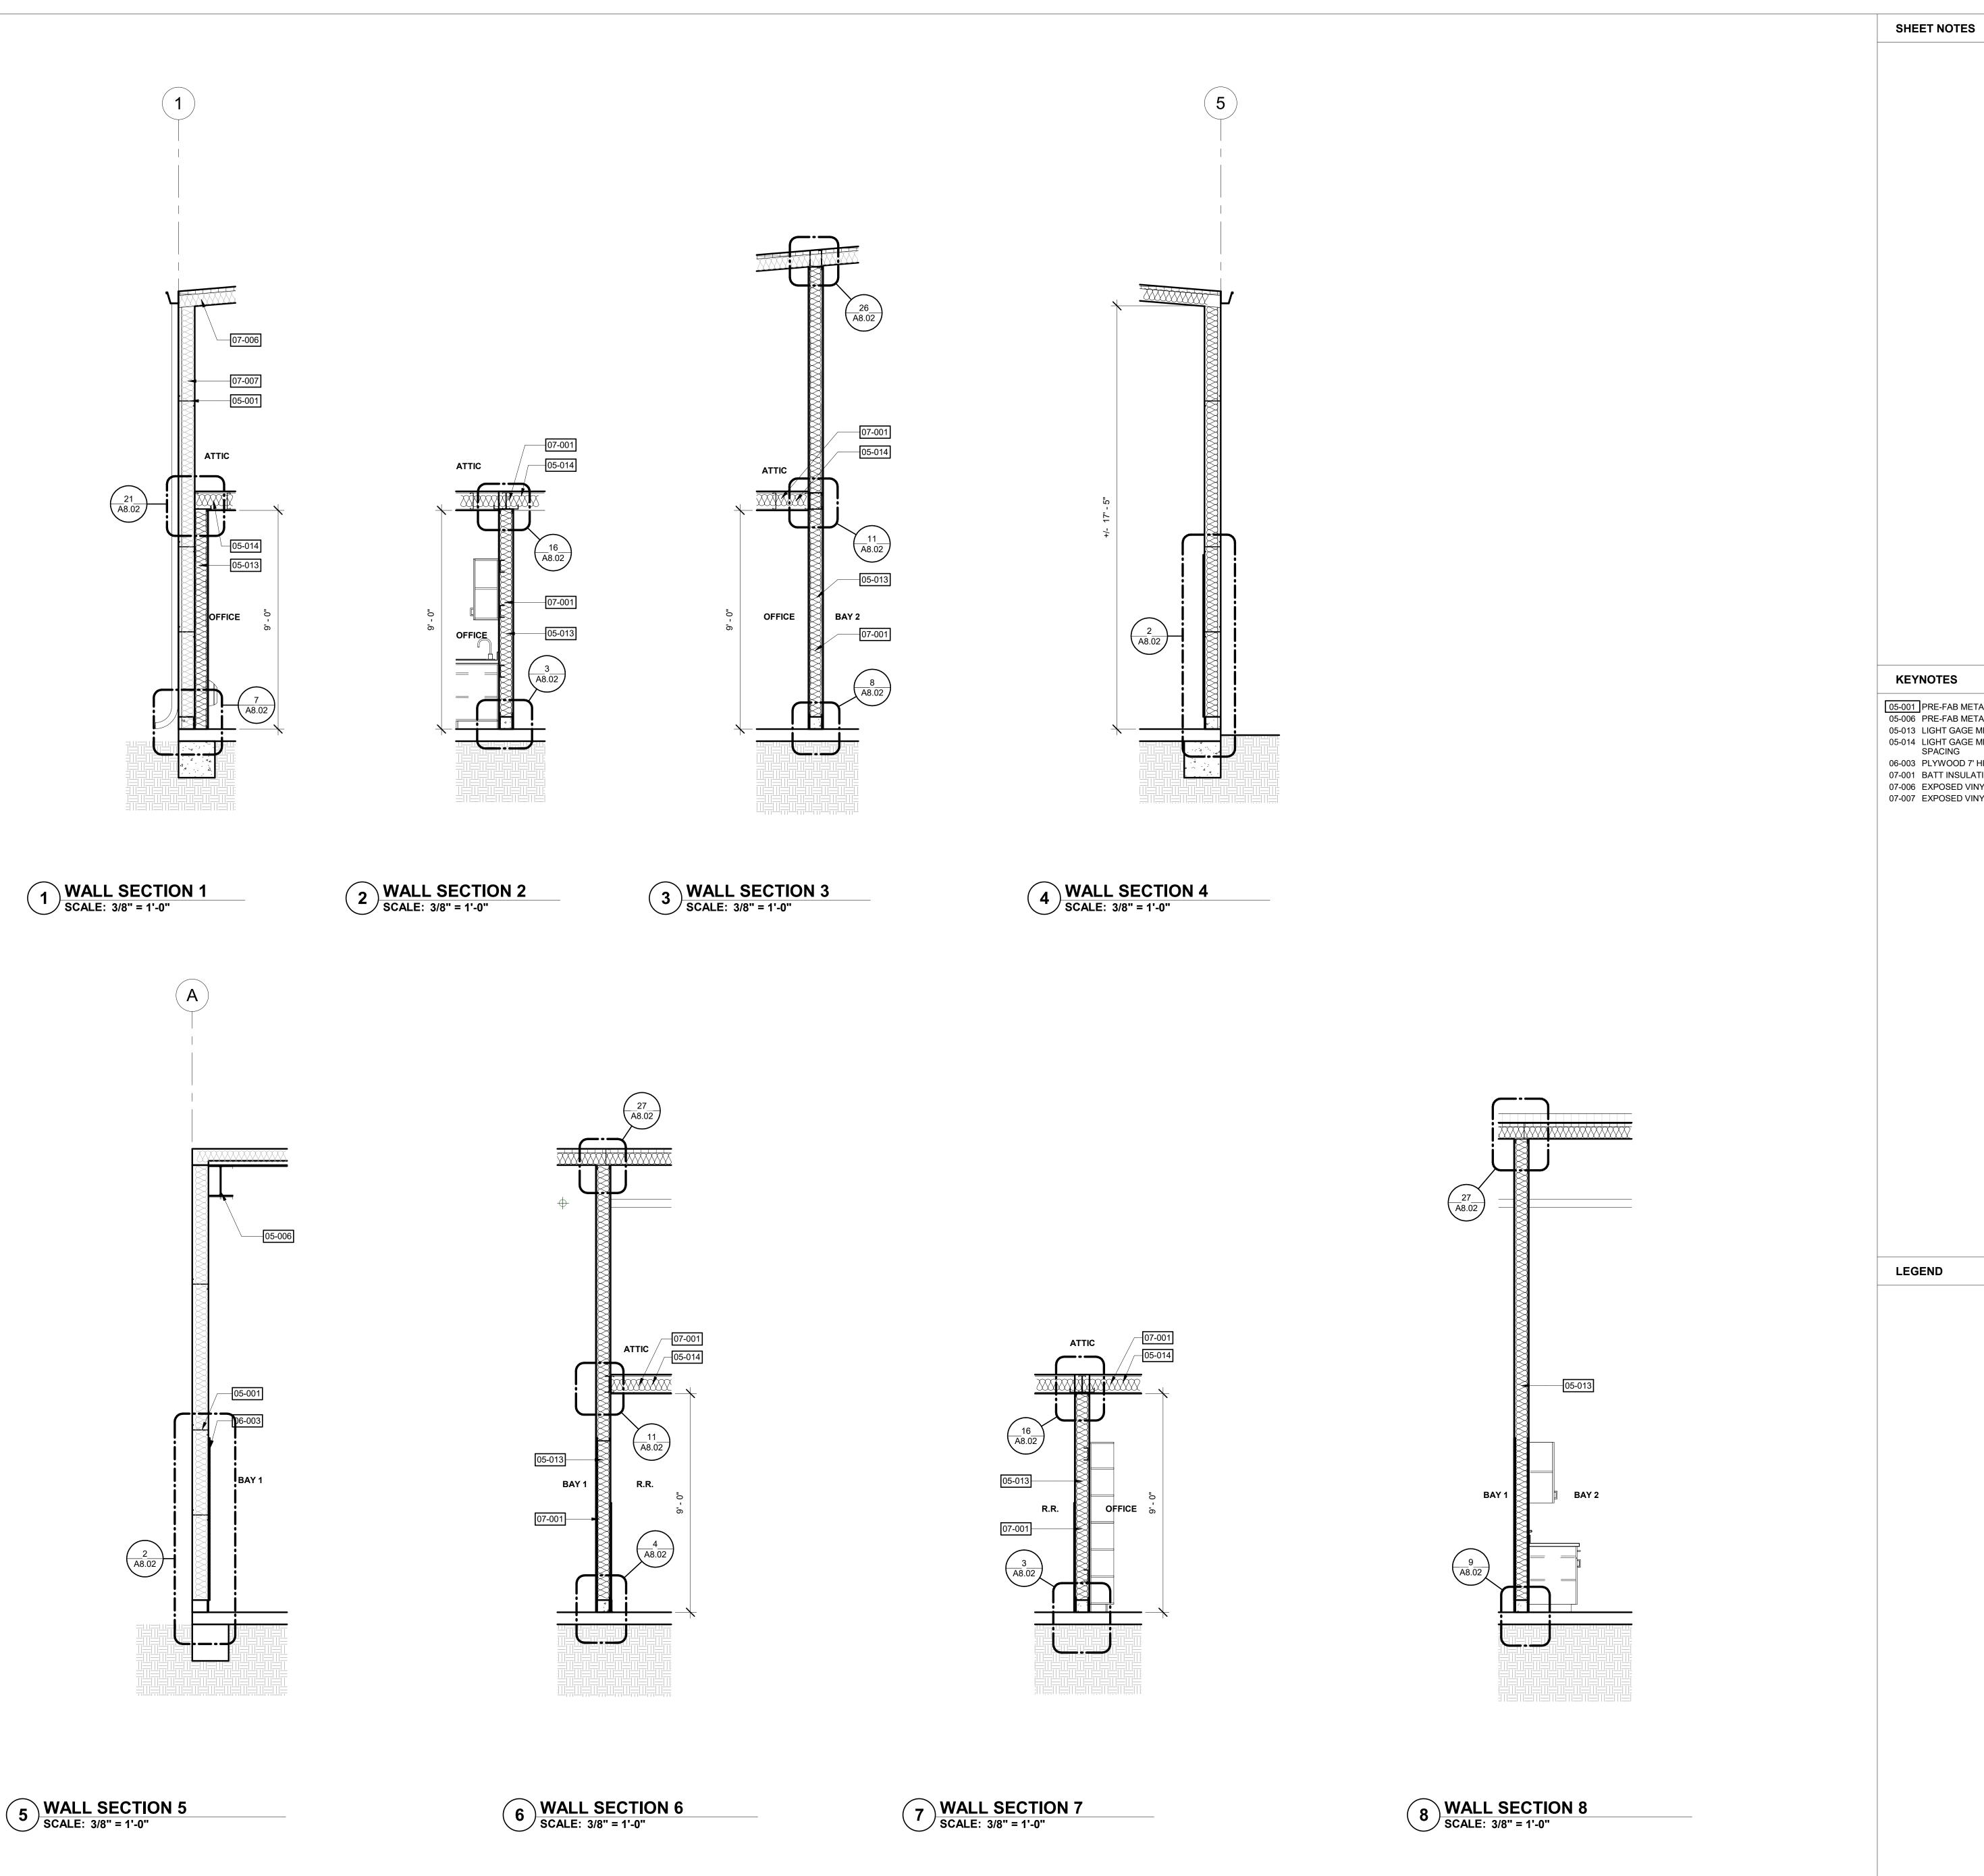

05-001 PRE-FAB METAL BUILDING SIDE WALL GIRTS - SEE SHOP DWGS. 05-006 PRE-FAB METAL BUILDING CROSS BRACING - SEE SHOP DWGS. 05-013 LIGHT GAGE METAL STUD WALLS REFER TO FLOOR PLAN FOR TYPE 05-014 LIGHT GAGE METAL JOISTSS REFER STRUCUTURAL PLANS FOR SIZE AND SPACING 06-003 PLYWOOD 7' HIGH OR TO GIRT AT DOOR HEADER HT.- PRIME PAINT 07-001 BATT INSULATIONS - SEE TITLE 24 SPECS 07-006 EXPOSED VINYL FACED R-19 INSULATION AT ROOF 07-007 EXPOSED VINYL FACED R-13 INSULATION AT WALL

Professional Seals

JOINT UNION ELEMENTARY SCHOOL DISTRICT

SHEET TITLE:
WALL SECTIONS


SCHEMATIC DESIGN

Revision Schedule Description


PROJECT # SHEET # 22.030 ISSUE DATE: 03-14-2023

A6.21


1 BAY 1 101 NORTH ELEVATION SCALE: 1/8" = 1'-0"

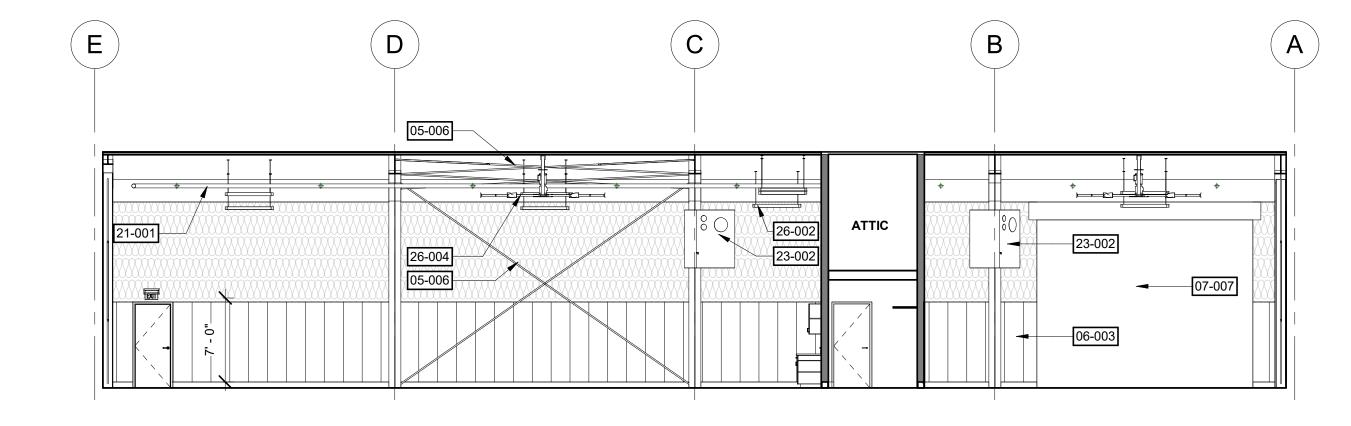


BAY 1 101 SOUTH ELEVATION
SCALE: 1/8" = 1'-0"

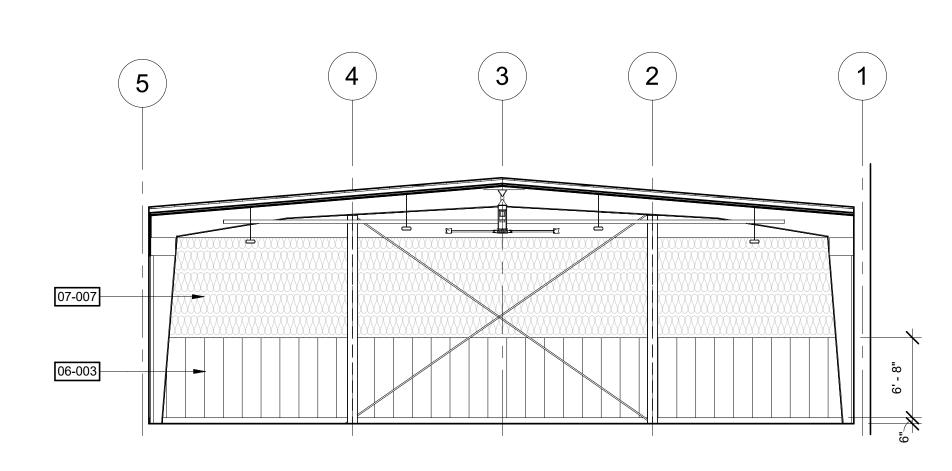


2 BAY 1 101 EAST ELEVATION
SCALE: 1/8" = 1'-0"

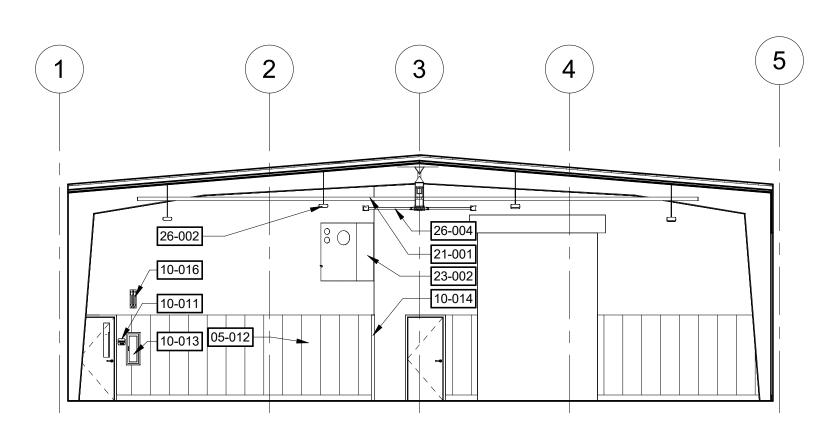

BAY 1 101 WEST ELEVATIONSCALE: 1/8" = 1'-0"

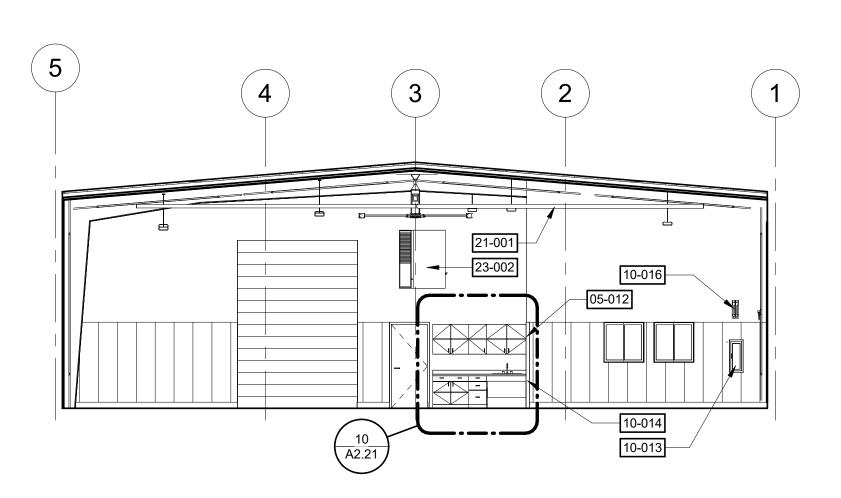

5 BAY 2 102 EAST ELEVATION SCALE: 1/8" = 1'-0"

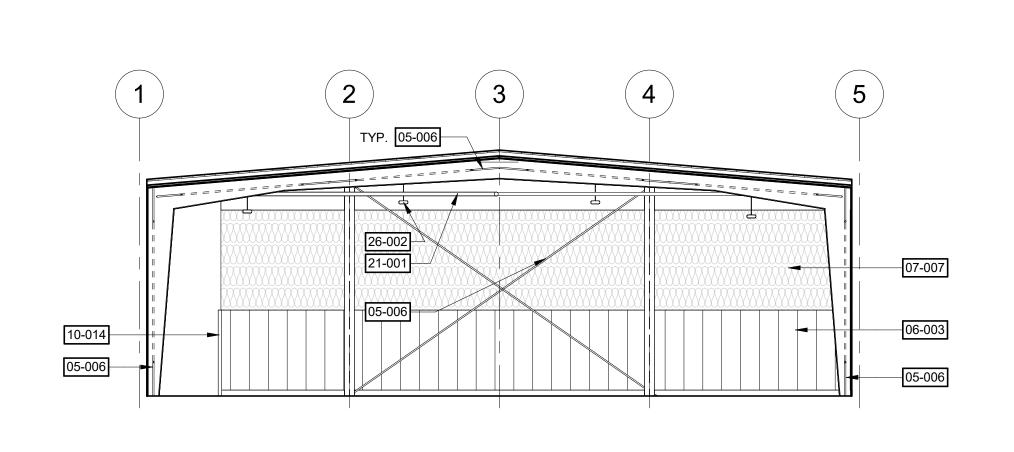

6 BAY 2 102 WEST ELEVATION SCALE: 1/8" = 1'-0"

KEYNOTES

LEGEND

SHEET NOTES

05-006 PRE-FAB METAL BUILDING CROSS BRACING - SEE SHOP DWGS.
05-012 ATTIC ACCESS LADDER

06-003 PLYWOOD 7' HIGH OR TO GIRT AT DOOR HEADER HT.- PRIME PAINT

07-007 EXPOSED VINYL FACED R-13 INSULATION AT WALL 10-011 ROOM IDENTIFICATION SIGN .


10-013 FIRE EXTINGUISHER MIN. RATING 2A:20-B:C 10-014 STAINLESS STEEL CORNER GUARDS

10-016 FIRE EXTINGUISHER PROJECTING '3-WAY' SIGN

21-001 FIRE SPRINKLER PIPING - SEE FIRE SPRINKLER PLANS 22-006 ELEC. WATER HEATER 30 GAL - SEE PLUMBING SPECS 23-002 GAS FIRED UNIT HEATER - SEE MECH DWGS

26-002 SUSPENDED LIGH FIXTURE - SEE ELEC. DWGS & SPECS 26-004 CEILING FANS - SEE ELEC. DWGS & SPECS

Professional Seals

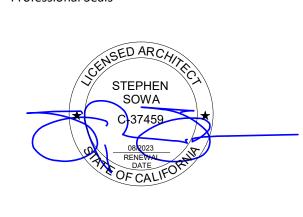

JOINT UNION ELEMENTARY SCHOOL DISTRICT

SHEET TITLE:
INTERIOR ELEVATIONS

SCHEMATIC DESIGN

Revision Schedule Description

PROJECT # SHEET # 22.030

A7.11

ISSUE DATE: 03-14-2023

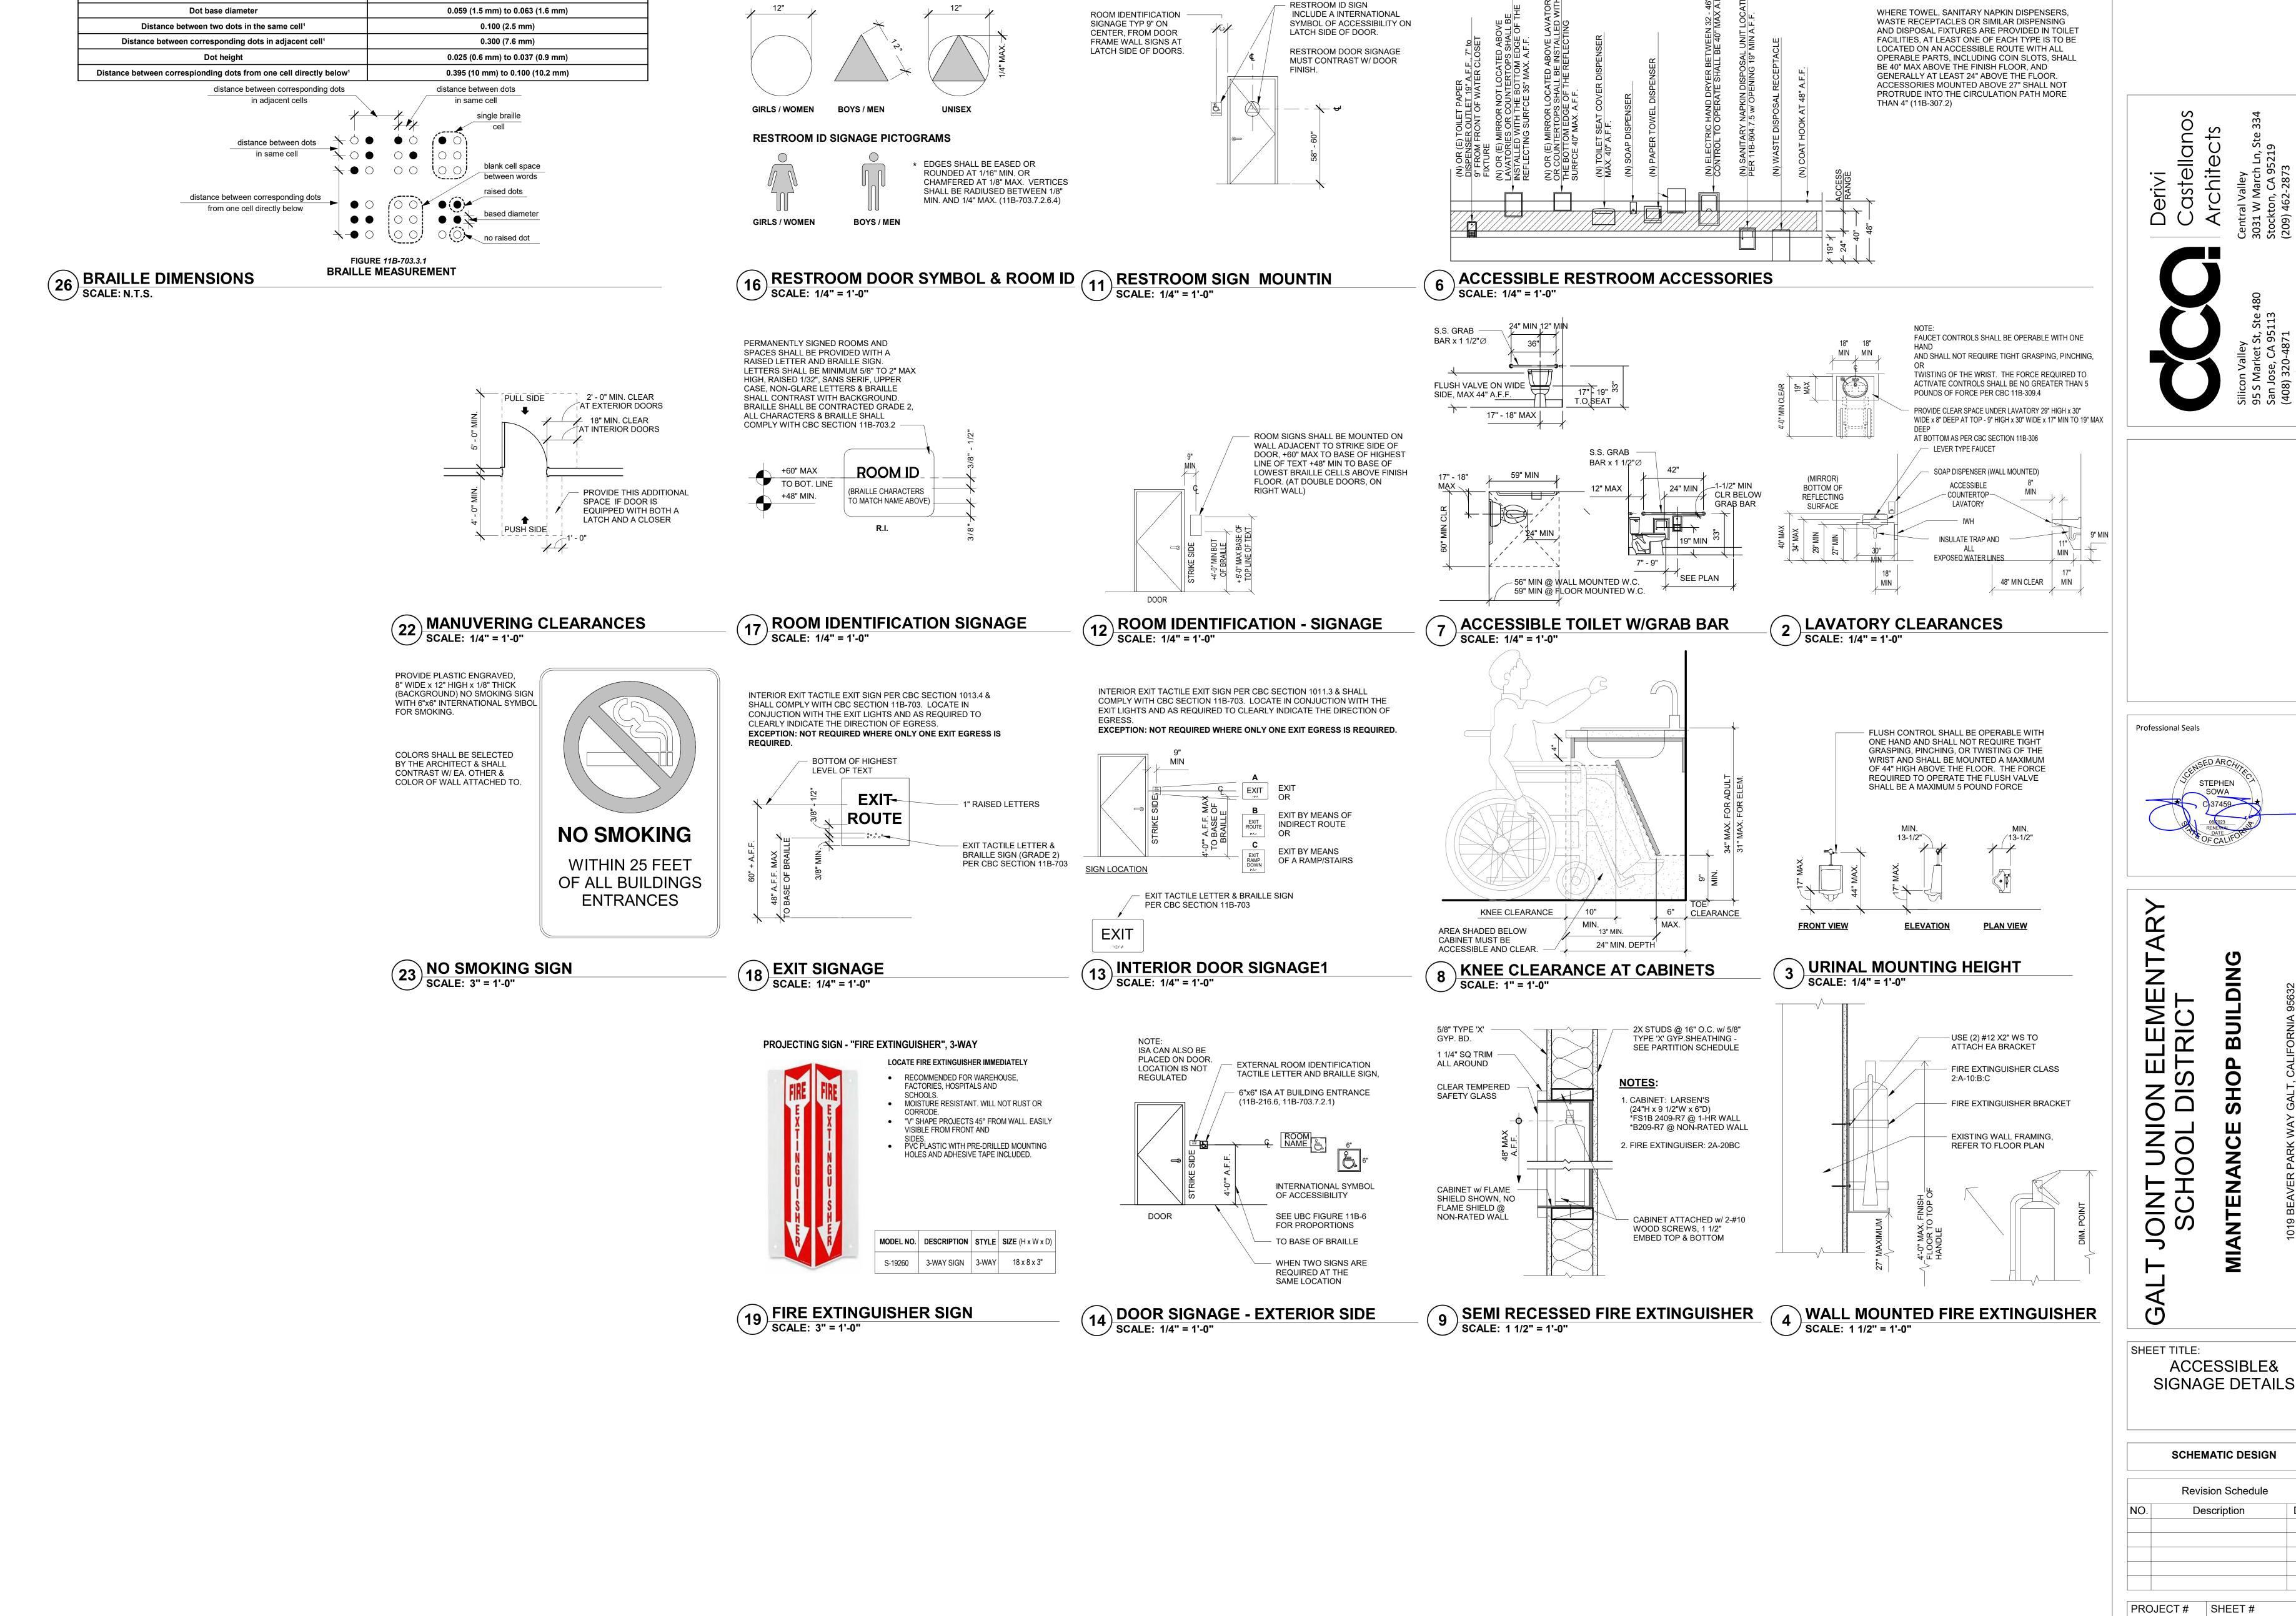


TABLE 11B-703.3.1 BRAILE DIMENSIONS


MEASUREMENT RANGE

MINIMUM IN INCHES

MAXIMUM IN INCHES

DOOR SYMBOL

22.030 ISSUE DATE: 03-14-2023

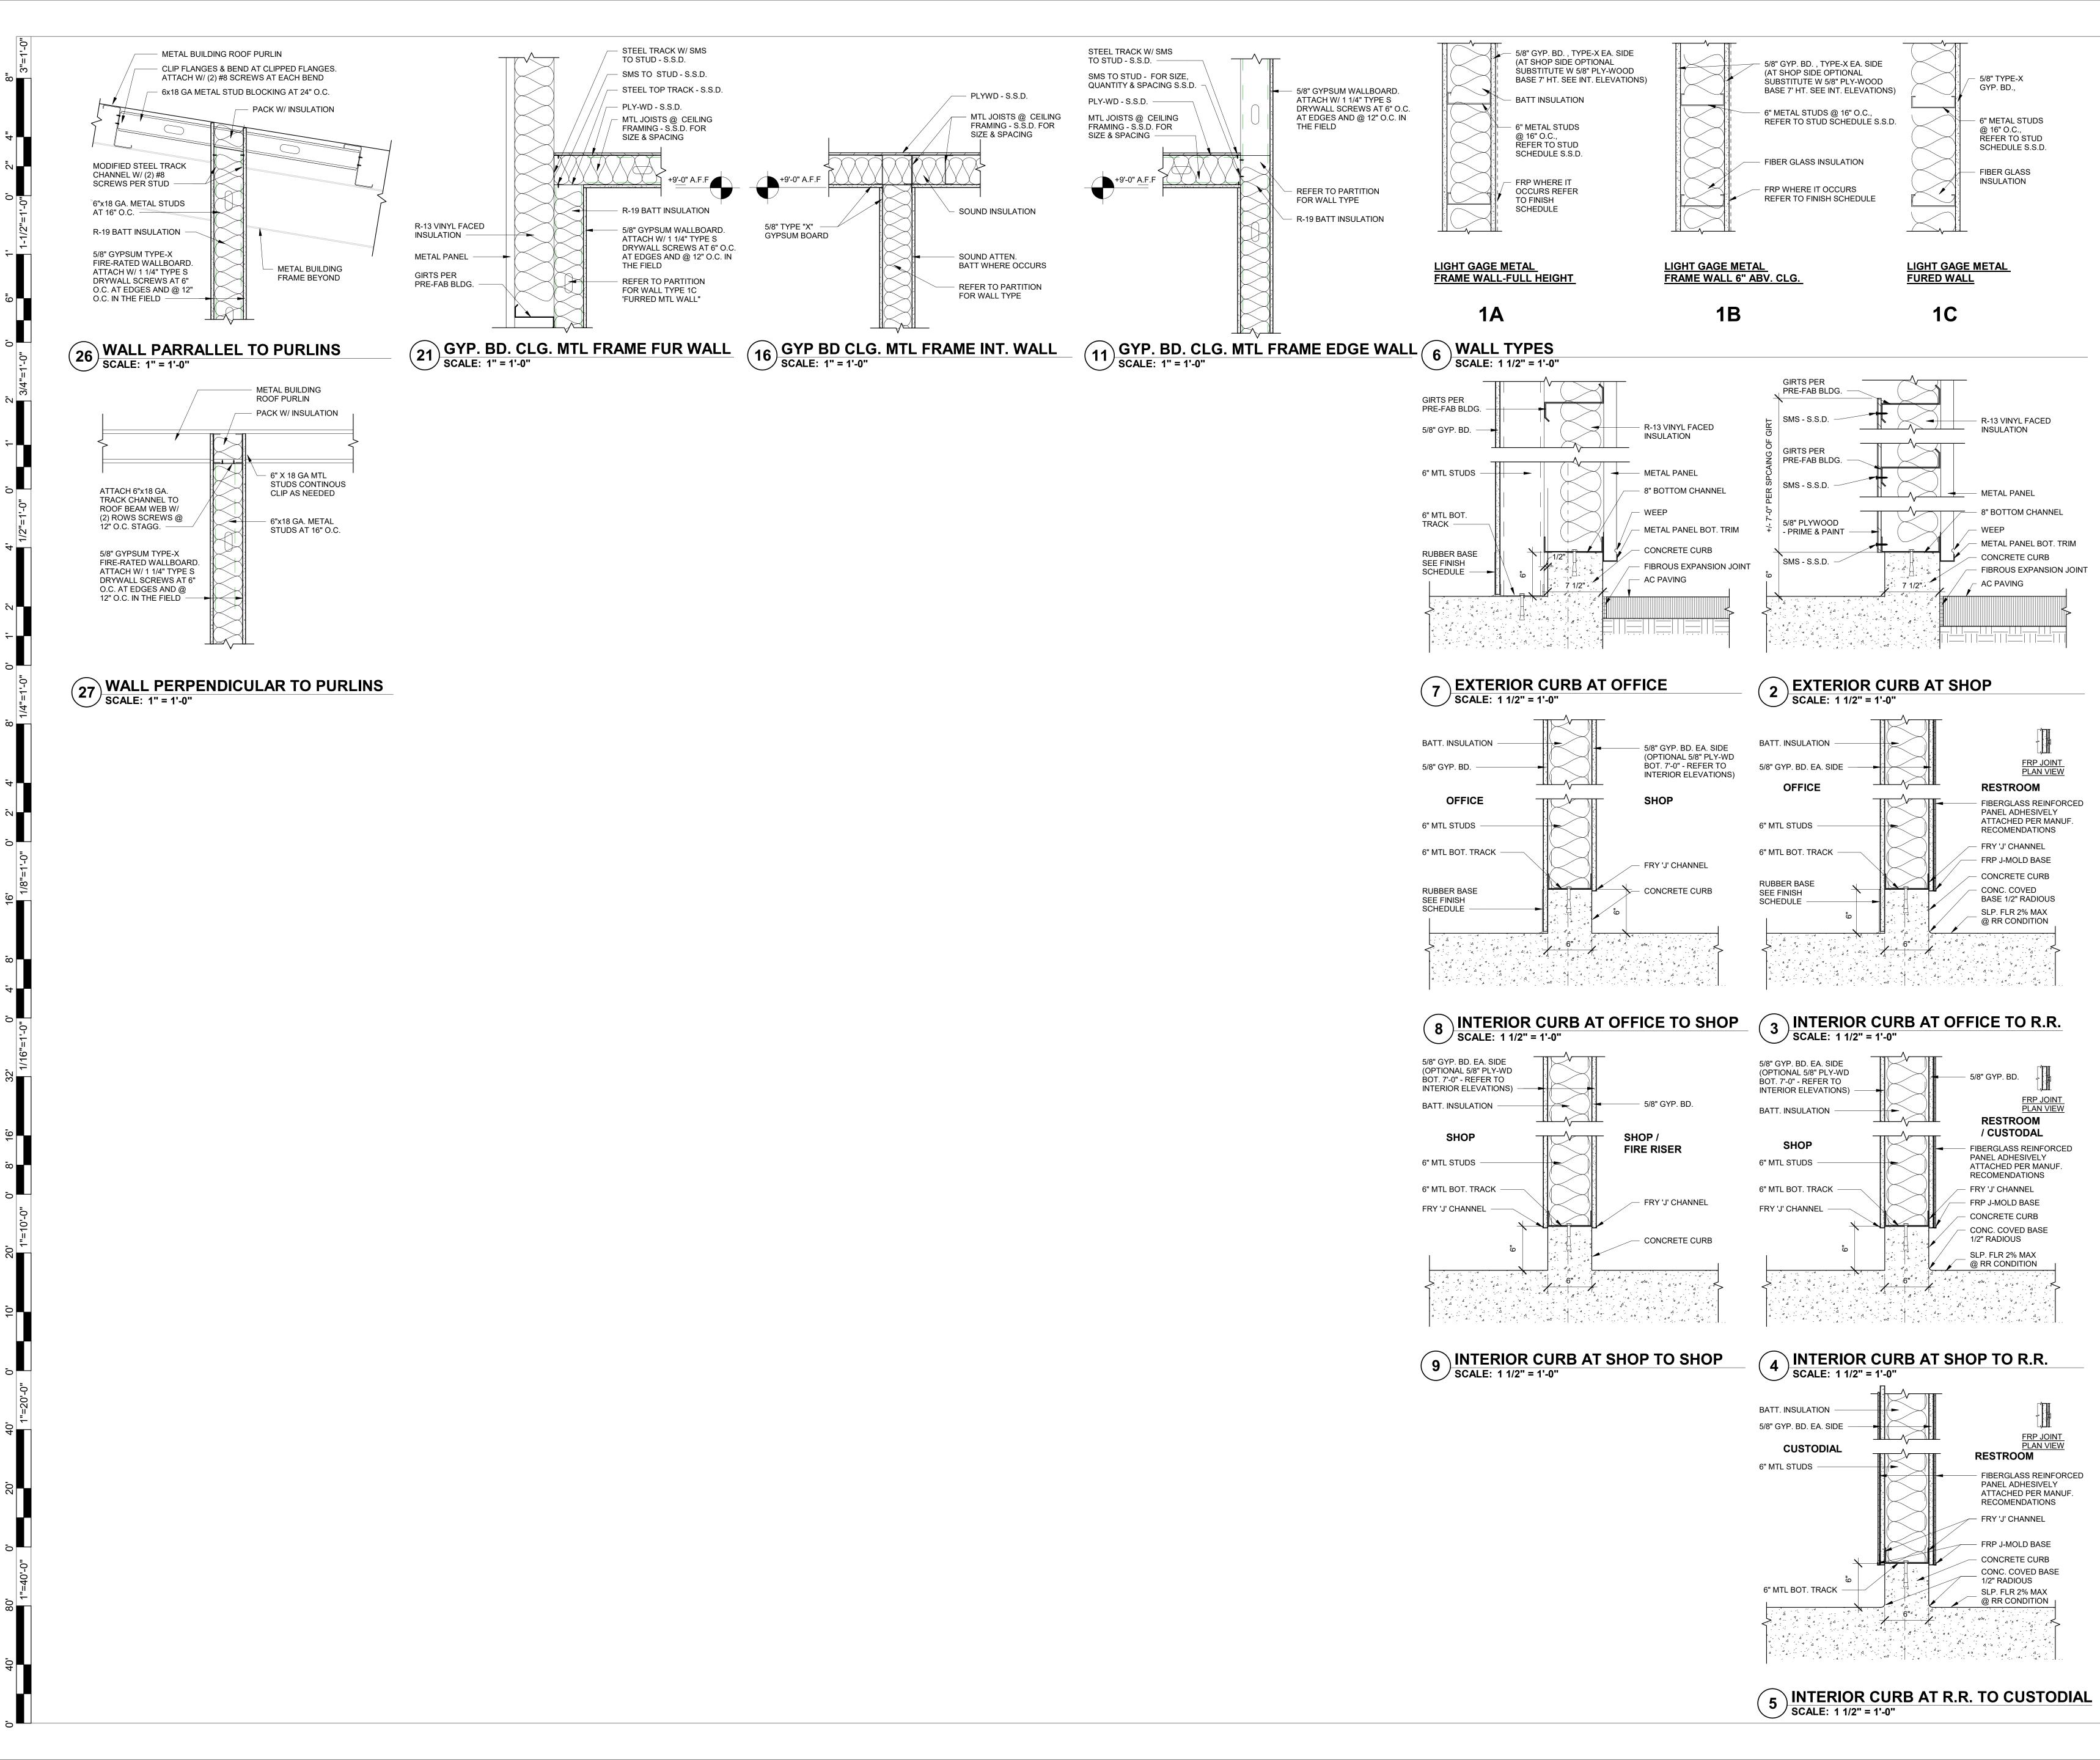

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SHEET TITLE: WALL AND FRAMING **DETAILS**

Castellanos Architects


Professional Seals

SCHEMATIC DESIGN

Revision Schedule Description

PROJECT # SHEET # 22.030

A8.02

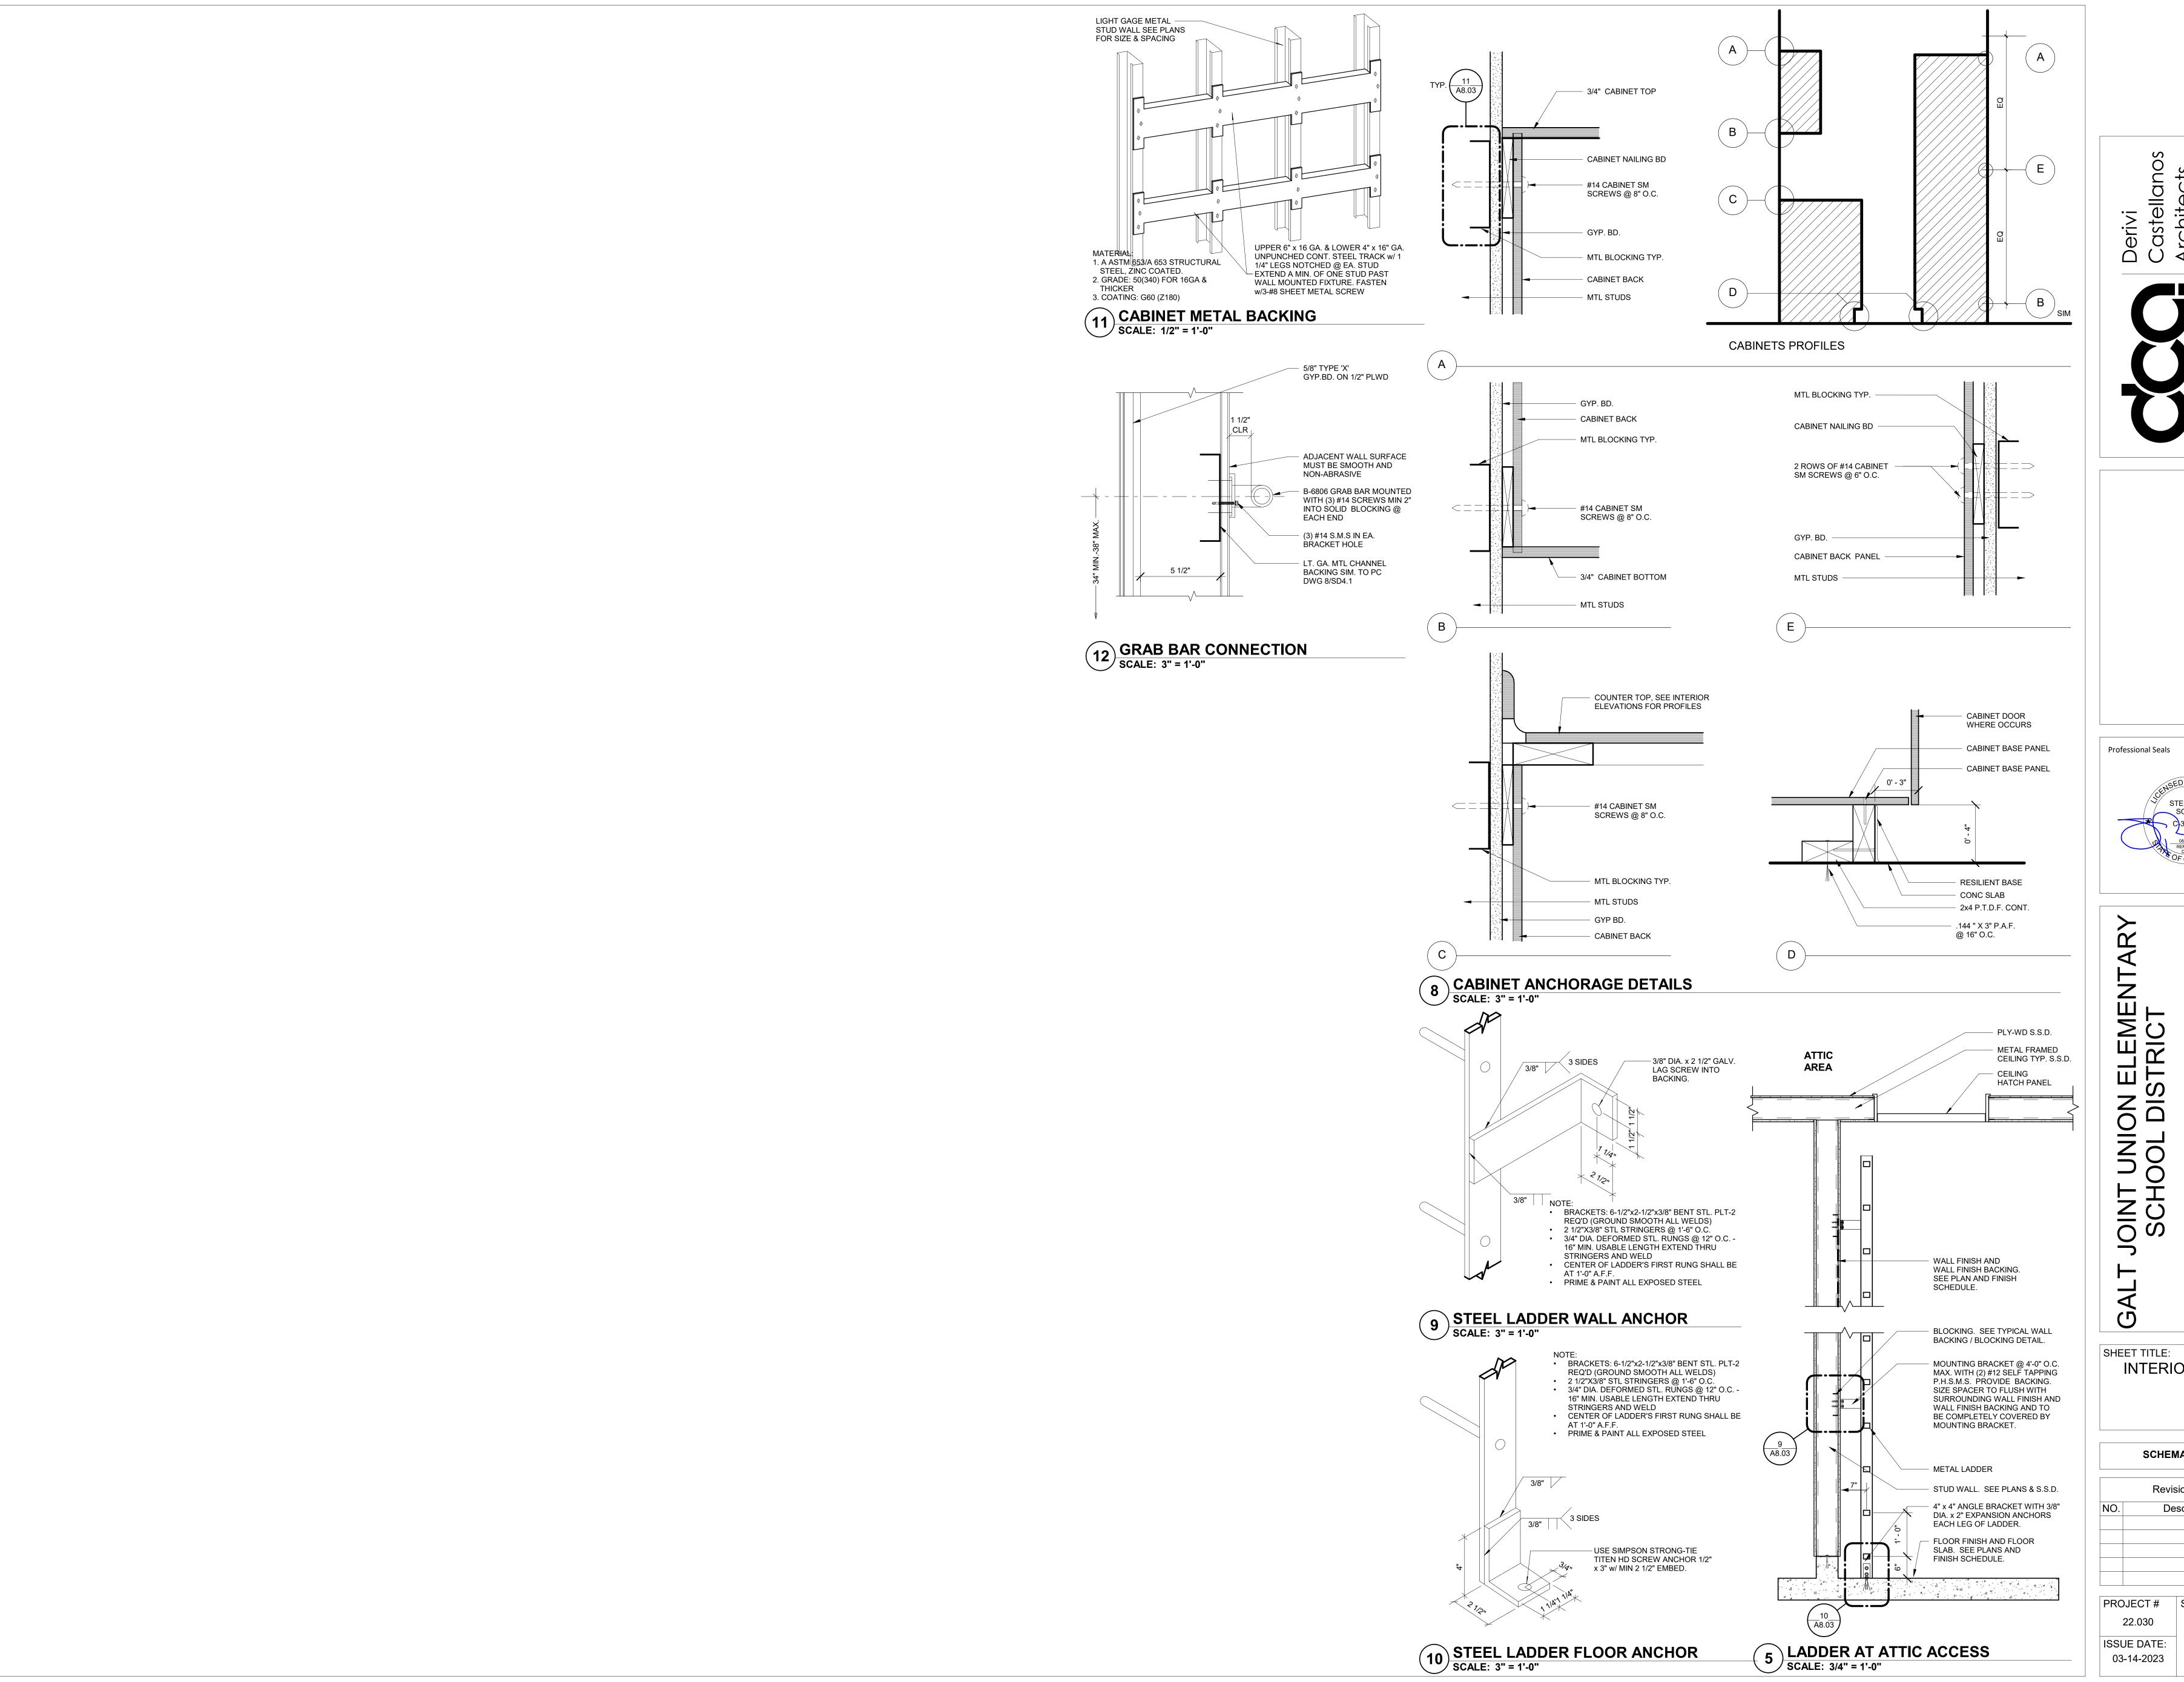


INTERIOR DETAILS

SCHEMATIC DESIGN Revision Schedule

Description PROJECT # SHEET #

A8.03

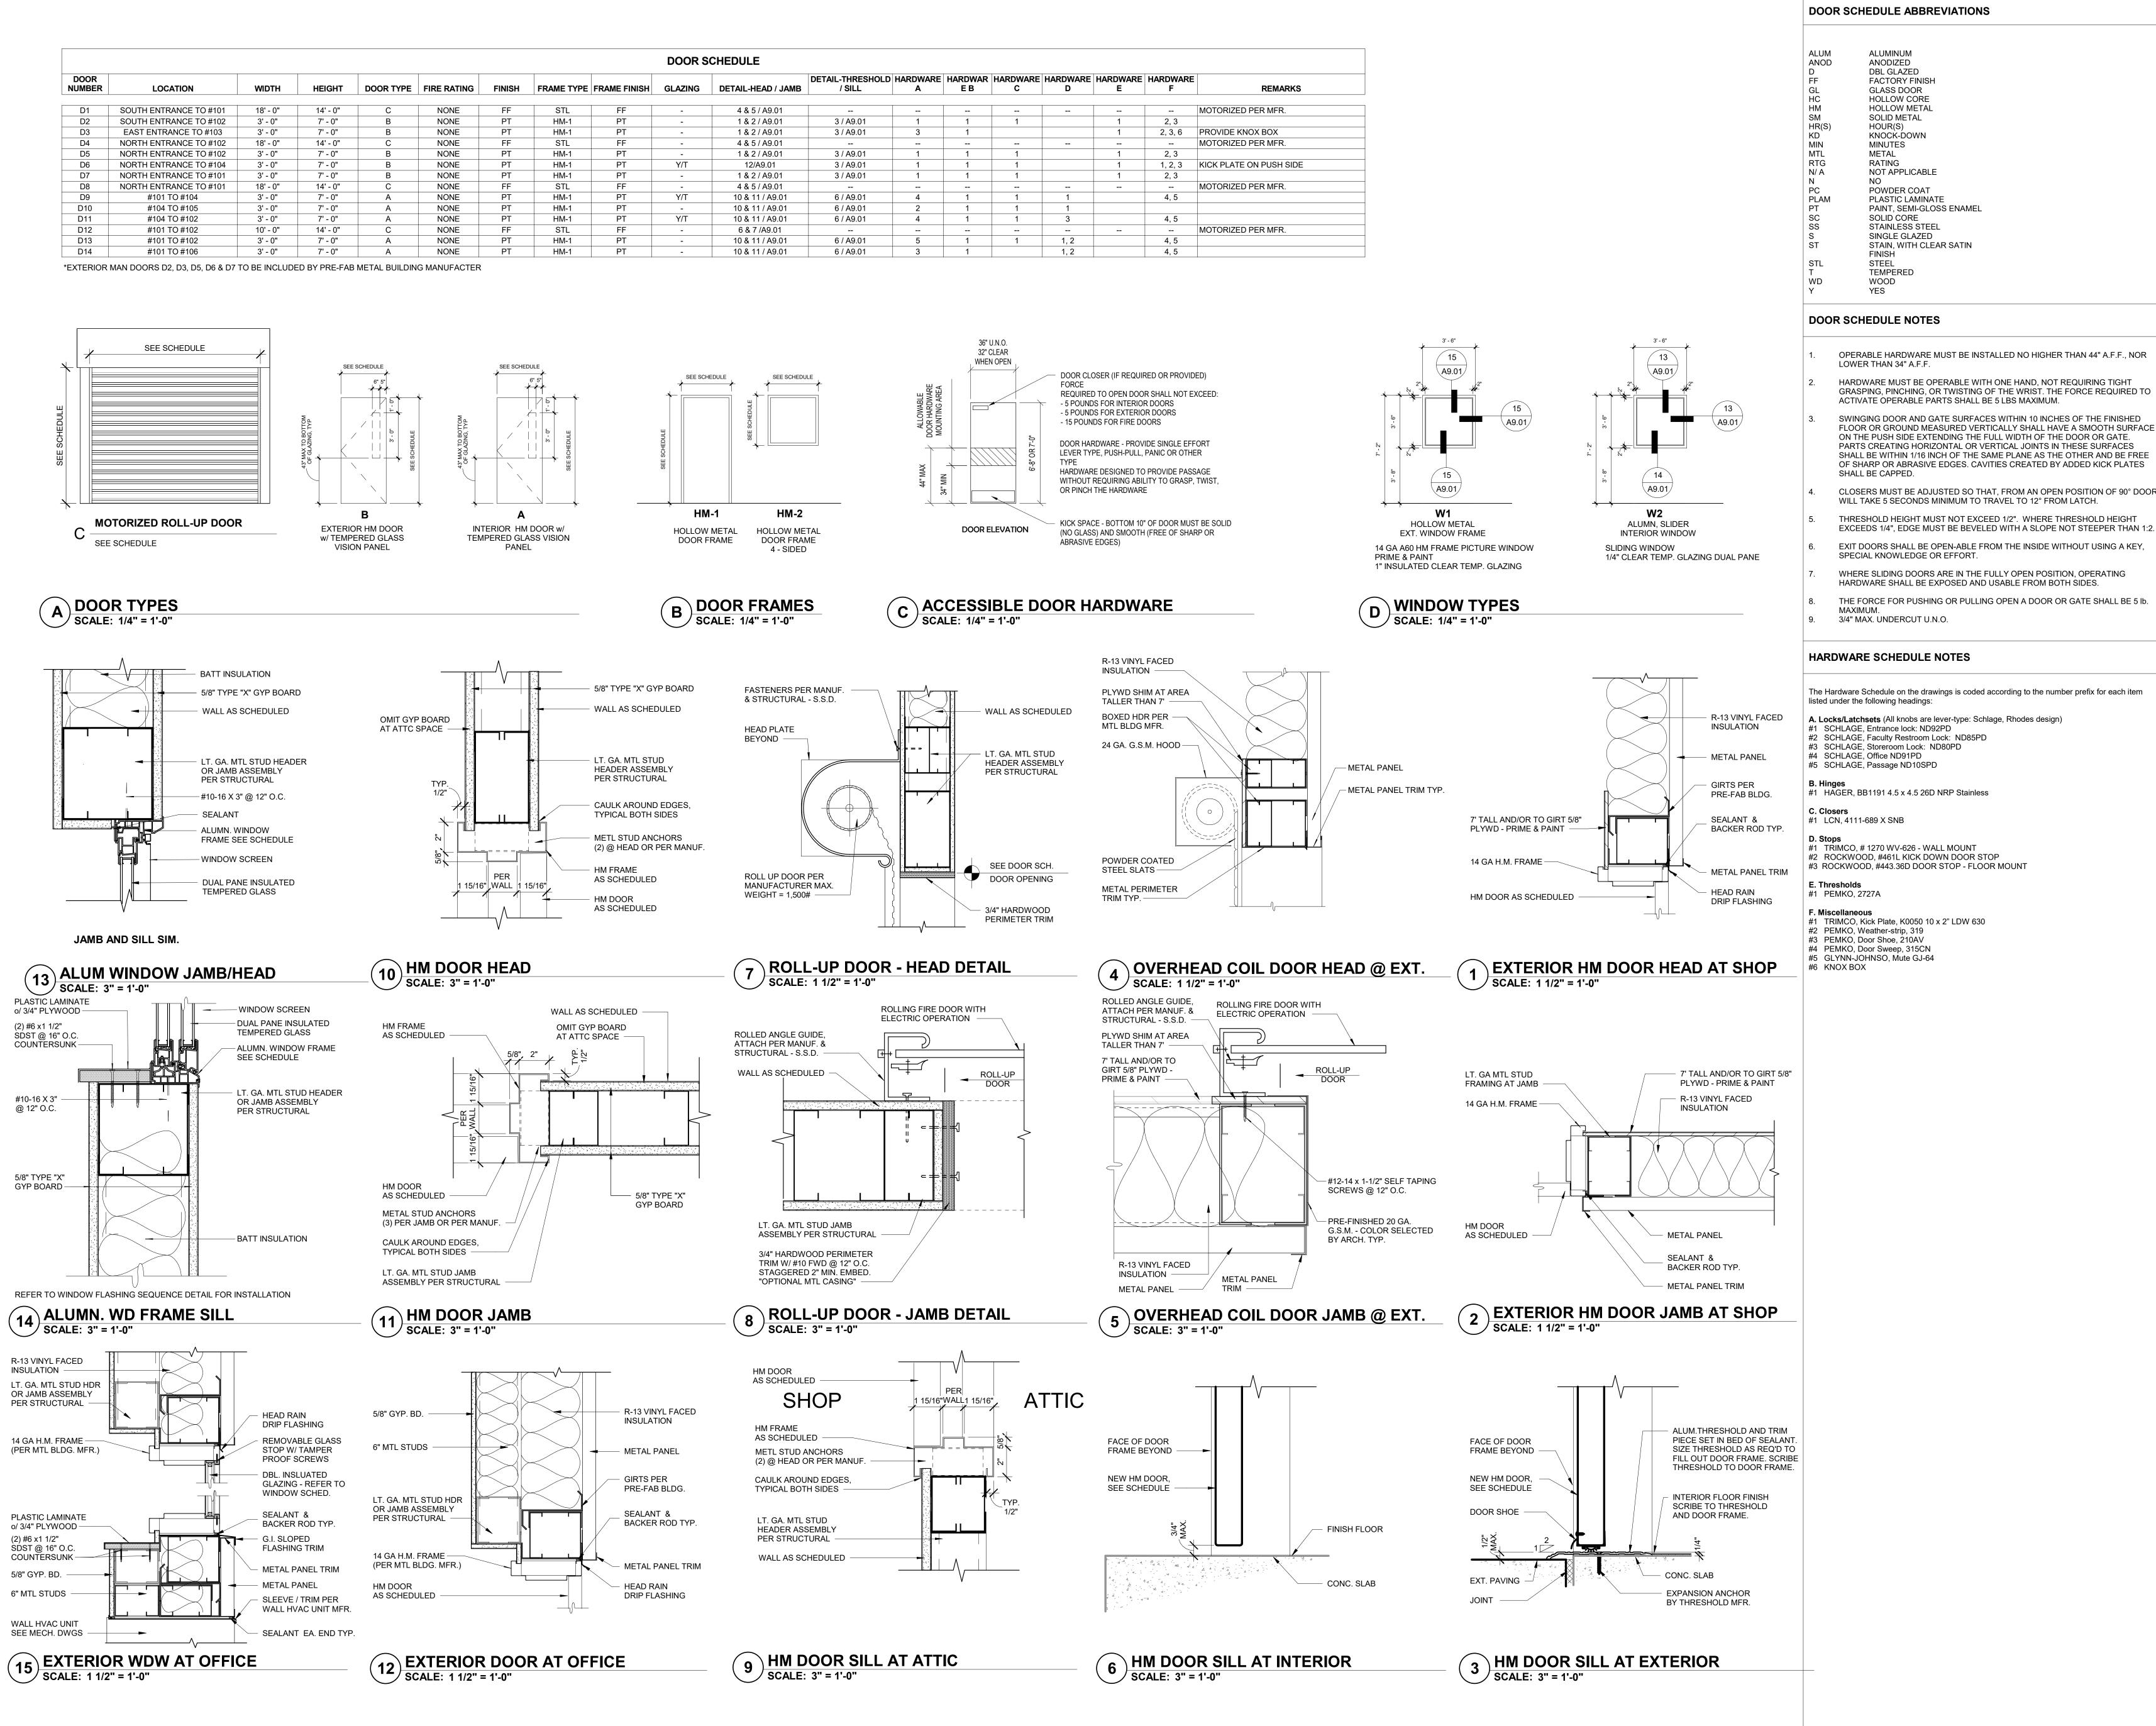

DBL GLAZED **FACTORY FINISH** GLASS DOOR **HOLLOW CORE** HOLLOW METAI SOLID METAL KNOCK-DOWN NOT APPLICABLE POWDER COAT

PLASTIC LAMINATE PAINT, SEMI-GLOSS ENAMEL SOLID CORE STAINLESS STEEL SINGLE GLAZED STAIN, WITH CLEAR SATIN

- OPERABLE HARDWARE MUST BE INSTALLED NO HIGHER THAN 44" A.F.F., NOR
- HARDWARE MUST BE OPERABLE WITH ONE HAND, NOT REQUIRING TIGHT GRASPING, PINCHING, OR TWISTING OF THE WRIST, THE FORCE REQUIRED TO
- SWINGING DOOR AND GATE SURFACES WITHIN 10 INCHES OF THE FINISHED FLOOR OR GROUND MEASURED VERTICALLY SHALL HAVE A SMOOTH SURFACE ON THE PUSH SIDE EXTENDING THE FULL WIDTH OF THE DOOR OR GATE. PARTS CREATING HORIZONTAL OR VERTICAL JOINTS IN THESE SURFACES SHALL BE WITHIN 1/16 INCH OF THE SAME PLANE AS THE OTHER AND BE FREE OF SHARP OR ABRASIVE EDGES. CAVITIES CREATED BY ADDED KICK PLATES
- CLOSERS MUST BE ADJUSTED SO THAT, FROM AN OPEN POSITION OF 90° DOOR WILL TAKE 5 SECONDS MINIMUM TO TRAVEL TO 12° FROM LATCH.
- THRESHOLD HEIGHT MUST NOT EXCEED 1/2". WHERE THRESHOLD HEIGHT
- EXIT DOORS SHALL BE OPEN-ABLE FROM THE INSIDE WITHOUT USING A KEY,
- WHERE SLIDING DOORS ARE IN THE FULLY OPEN POSITION, OPERATING HARDWARE SHALL BE EXPOSED AND USABLE FROM BOTH SIDES.
- THE FORCE FOR PUSHING OR PULLING OPEN A DOOR OR GATE SHALL BE 5 lb.

HARDWARE SCHEDULE NOTES

The Hardware Schedule on the drawings is coded according to the number prefix for each item

A. Locks/Latchsets (All knobs are lever-type: Schlage, Rhodes design) #1 SCHLAGE, Entrance lock: ND92PD


#2 SCHLAGE, Faculty Restroom Lock: ND85PD #3 SCHLAGE, Storeroom Lock: ND80PD

#1 TRIMCO, # 1270 WV-626 - WALL MOUNT #2 ROCKWOOD, #461L KICK DOWN DOOR STOP

#1 TRIMCO, Kick Plate, K0050 10 x 2" LDW 630 #2 PEMKO, Weather-strip, 319 #3 PEMKO, Door Shoe, 210AV

Professional Seals

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SHEET TITLE: DOOR SCHEDULE
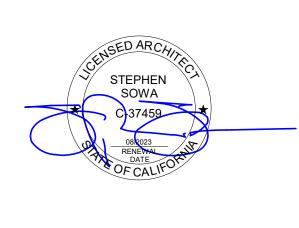
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SCHEMATIC DESIGN

Revision Schedule Description

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